
PROJECT TITLE: HYDRO ONE - SOUTHWESTERN ONTARIO REGION ADMINISTRATION BUILDING

PROJECT LOCATION: CITY OF LONDON, ONTARIO


PROJECT NUMBER: WDIV-W24-02

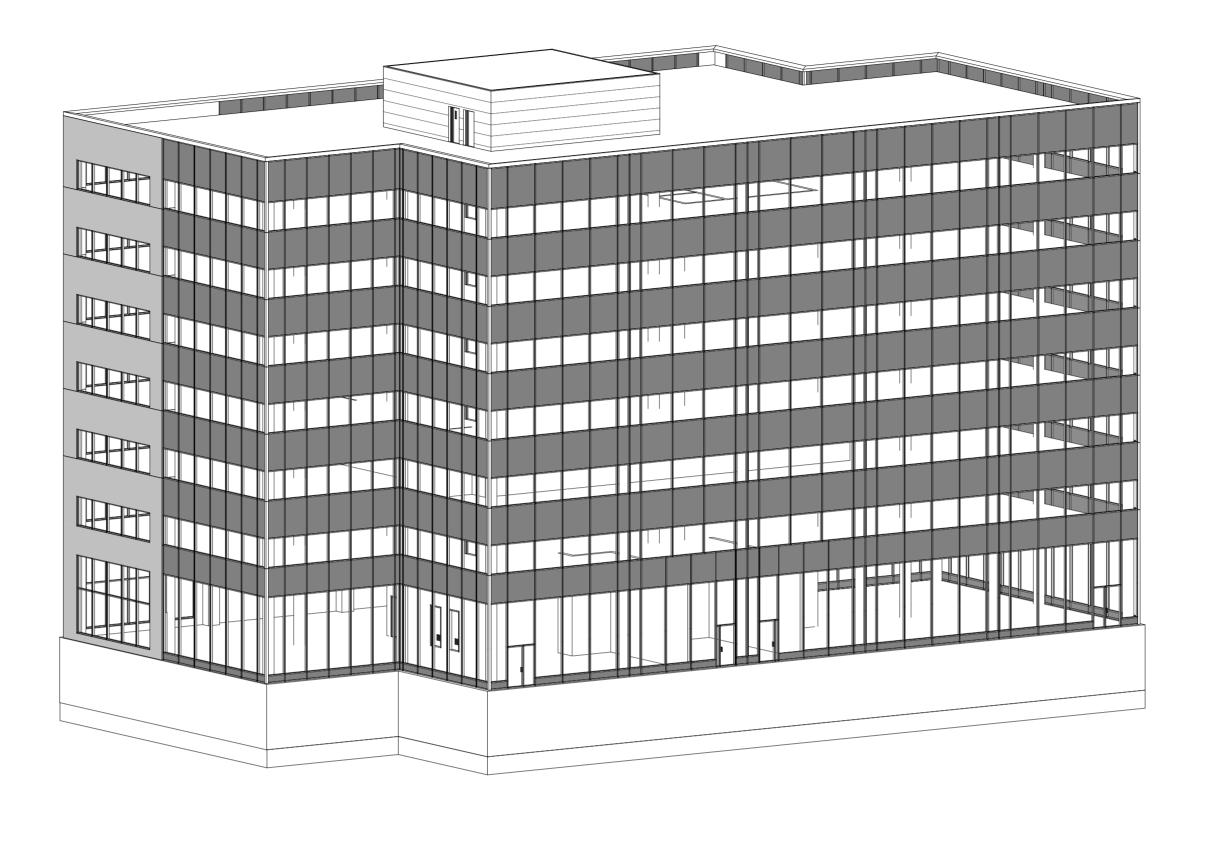


DRAWING LIST	
SHEET NUMBER	DRAWING TITLE
A-101 A-102	GROUND FLOOR PLAN THIRD FLOOR PLAN
A-201	BUILDING SECTION
A-301	EXTERIOR ELEVATIONS -NORTH ELEVATION
A-302	EXTERIOR ELEVATIONS
A-303	-EAST ELEVATION -WEST ELEVATION EXTERIOR ELEVATIONS -SOUTH ELEVATION
A-401 A-402	WALL SECTION DETAILS PLAN DETAILS
A-501	STAIR PLAN & SECTION
A-601	REFLECTED CEILING PLAN
A-701 A-702	WASHROOM PLAN WASHROOM ELEVATIONS
A-801	CONSTRUCTION ASSEMBLIES

Name	of Practice: Algonquin Centre f Architectural Techn ARC8404C - Work Winter 2024		lence			ALGON	DLLEGE	Algon Censt	quin Centre for ruction Excellence
	of Project: One – Southwestern (Ontario Region Admir	nistration Building	at D					
Locati City of	ion: f London, Ontario								
	itted by: Cheung 040864137								
Date: April	10, 2024								
		Ontario Builo	ling Code Dat Part 3	ta Mat	rix				Building Code Reference
3.00	Building Code Version:	O. Reg. 332/12	<u> </u>	100	ast mendment	O. Reg.	89/23		
3.01	Project Type:	⊠ New Construction						[A] 1.1.22.	
3.02	Major Occupancy Classification:	Occupancy D	Use Business A	dminis	tration				3.1.2.
		E F2		C. M. C. S.			_		
3.04	Building Area (m²)	Description:			Existing	New	Total		[A] 1.4.1.2.
		Ground Floor			0	1214.5		0	-
					0	0		0	-
	1				0	0		0	-
	Insert additional lines as				0	0	<u> </u>	0	-


3.05	Gross Area (m²)	Description: Existing New Total	[A] 1.4.1.2.
		1st Floor 0 0 0	
		0 0 0	
		0 0 0	
		0 0 0	
	Insert additional lines as needed	Total 0 0 0	
3.07	Building Height		[A] 1.4.1.2. & 3.2.1.1.
3.08	High Building	⊠ No □ Yes	3.26.
3.09	Number of Streets/ Firefighter access	1street(s)	3.2.2.10. & 3.2.5.
3.10	Building Classification: (Size & Construction Relative to Occupancy)	3.2.2.49 Group/Div GROUP D	3.2.2.20 - 83.
3.11	Sprinkler System	☑ Required ☐ Not Required Provided: ☑ entire building ☐ selected compartments ☐ selected floor areas ☐ basement ☐ in lieu of roof rating ☐ none Description: ☐	3.2.1.5. & 3.2.2.17., 3.2.2.18., 3.2.4.8 to 3.2.4.10., and 3.2.5.13
3.12	Standpipe System	□ Not required ⊠ Required	3.29.
3.13	Fire Alarm System	☑ Required ☐ Not required Type Provided: ☐ Single stage ☐ Two stage ☐ None	3.24.
3.15	Construction Type:	Restriction: □ Combustible permitted □ Non-combustible required □ Encapsulated mass timber Actual: □ Combustible □ Non-combustible □ Combination of combustible and non-combustible □ Encapsulated mass timber □ Combination of encapsulated mass timber and non-combustible Heavy Timber Construction: ☑ No □ Yes	3.22.2083. &

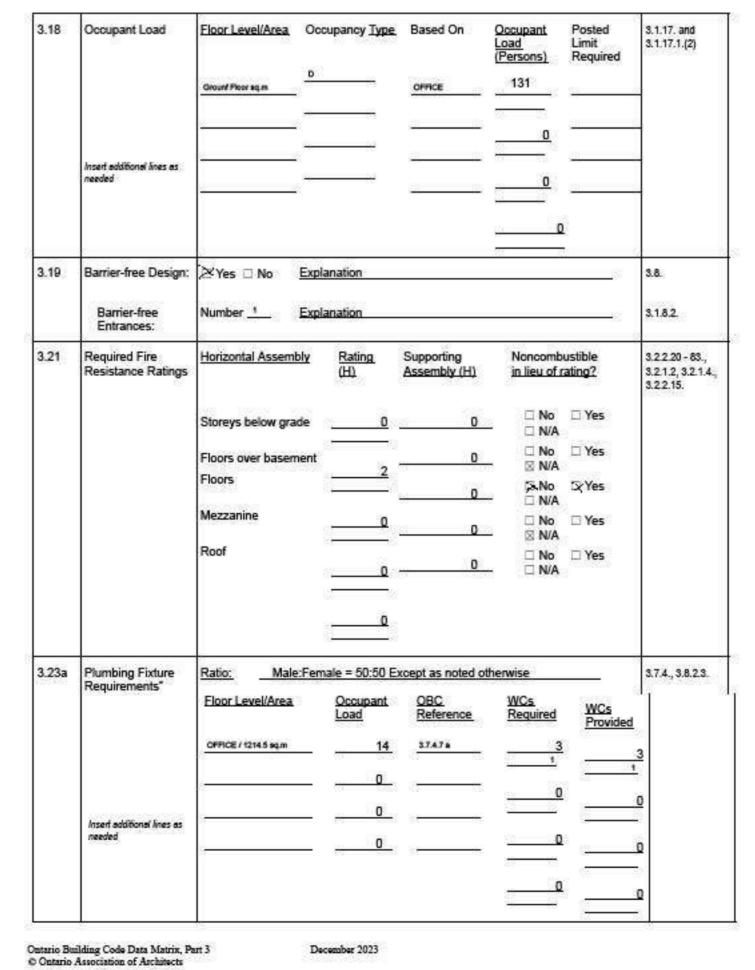

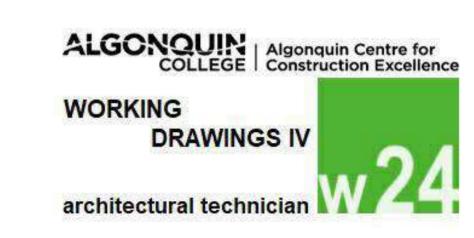

NAME: JAMIE CHEUNG STUDENT No.: 040864137 SECTION: 24W_ARC8404C_030 COURSE: WORKING DRAWINGS IV SEMESTER: WINTER 2024

DATE: APRIL 10, 2024

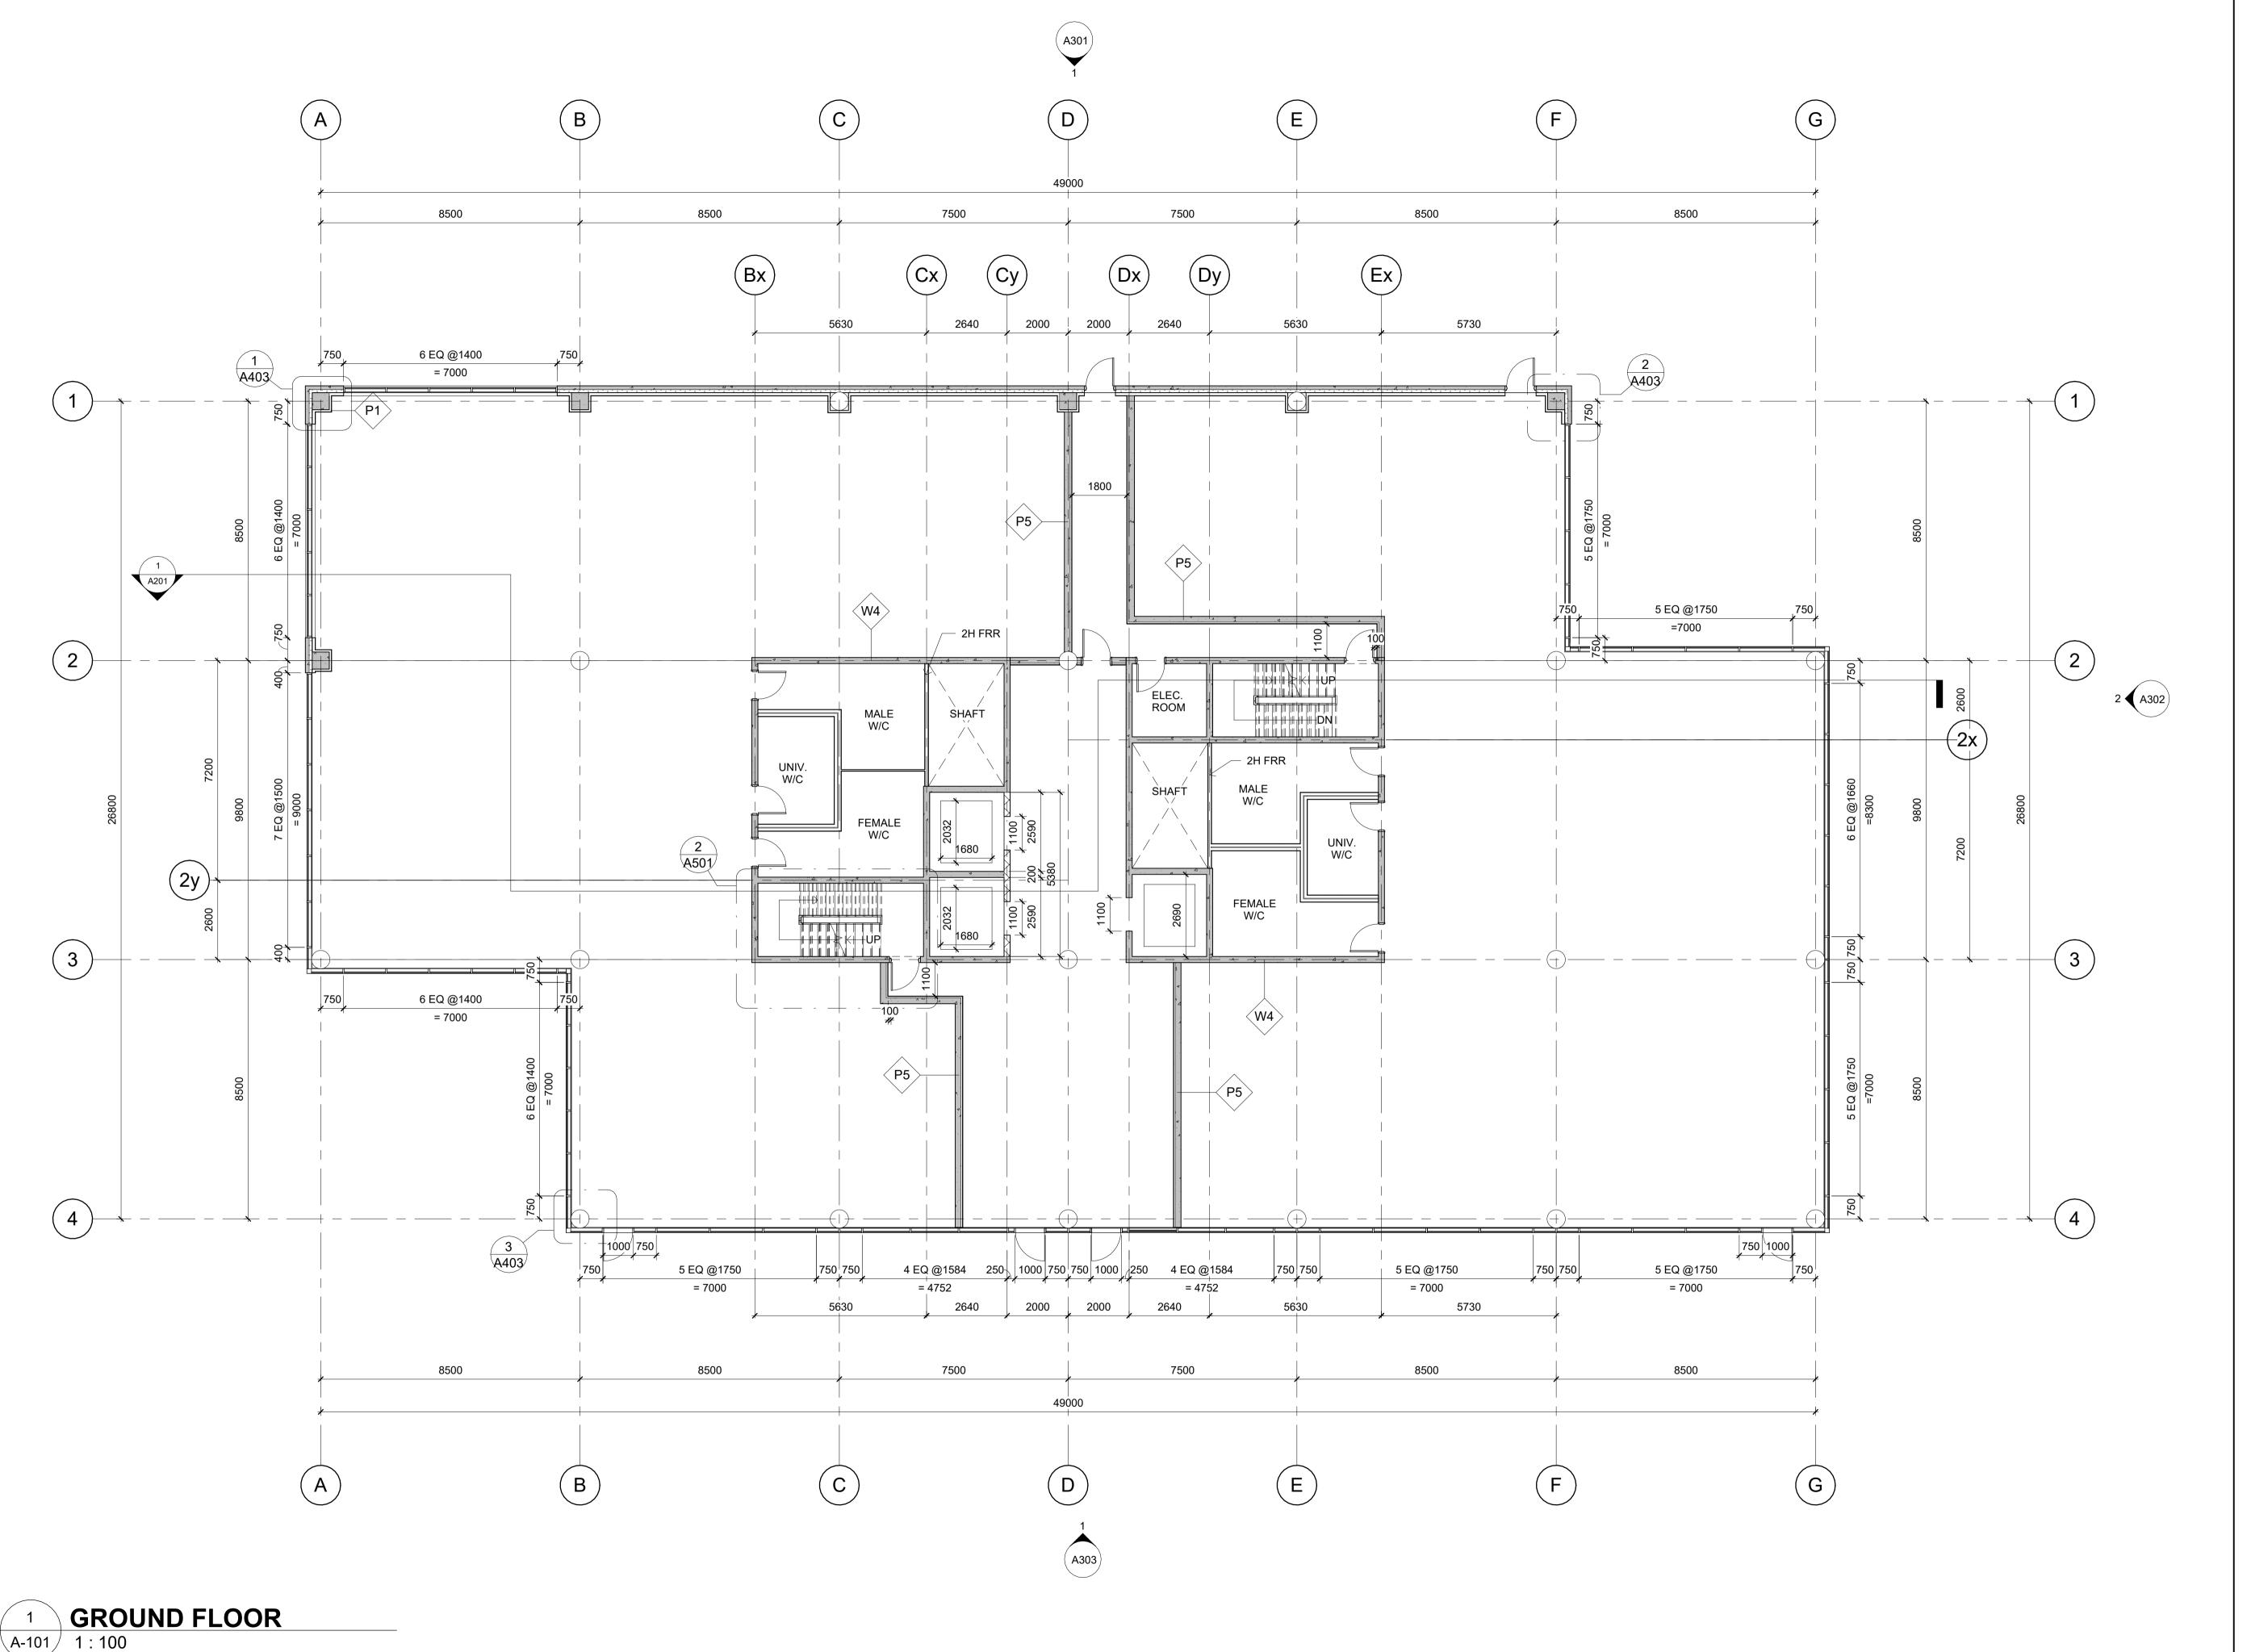

A302 1

DO NOT SCALE DRAWINGS


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01 FINAL SUBMISSION 10/04/2024
No. Revision Date

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WORKING DRAWINGS IV

architectural technician

PROJECT TITLE:

HYDRO ONE - SOUTHWESTERN ONTARIO REGION ADMINISTRATION BUILDING

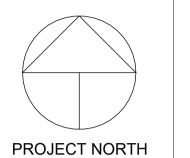DRAWING TITLE:


GROUND FLOOR


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JAMIE CHEUNG

PROJECT NUMBER: UNDIV-W24-02

SHEET No.:



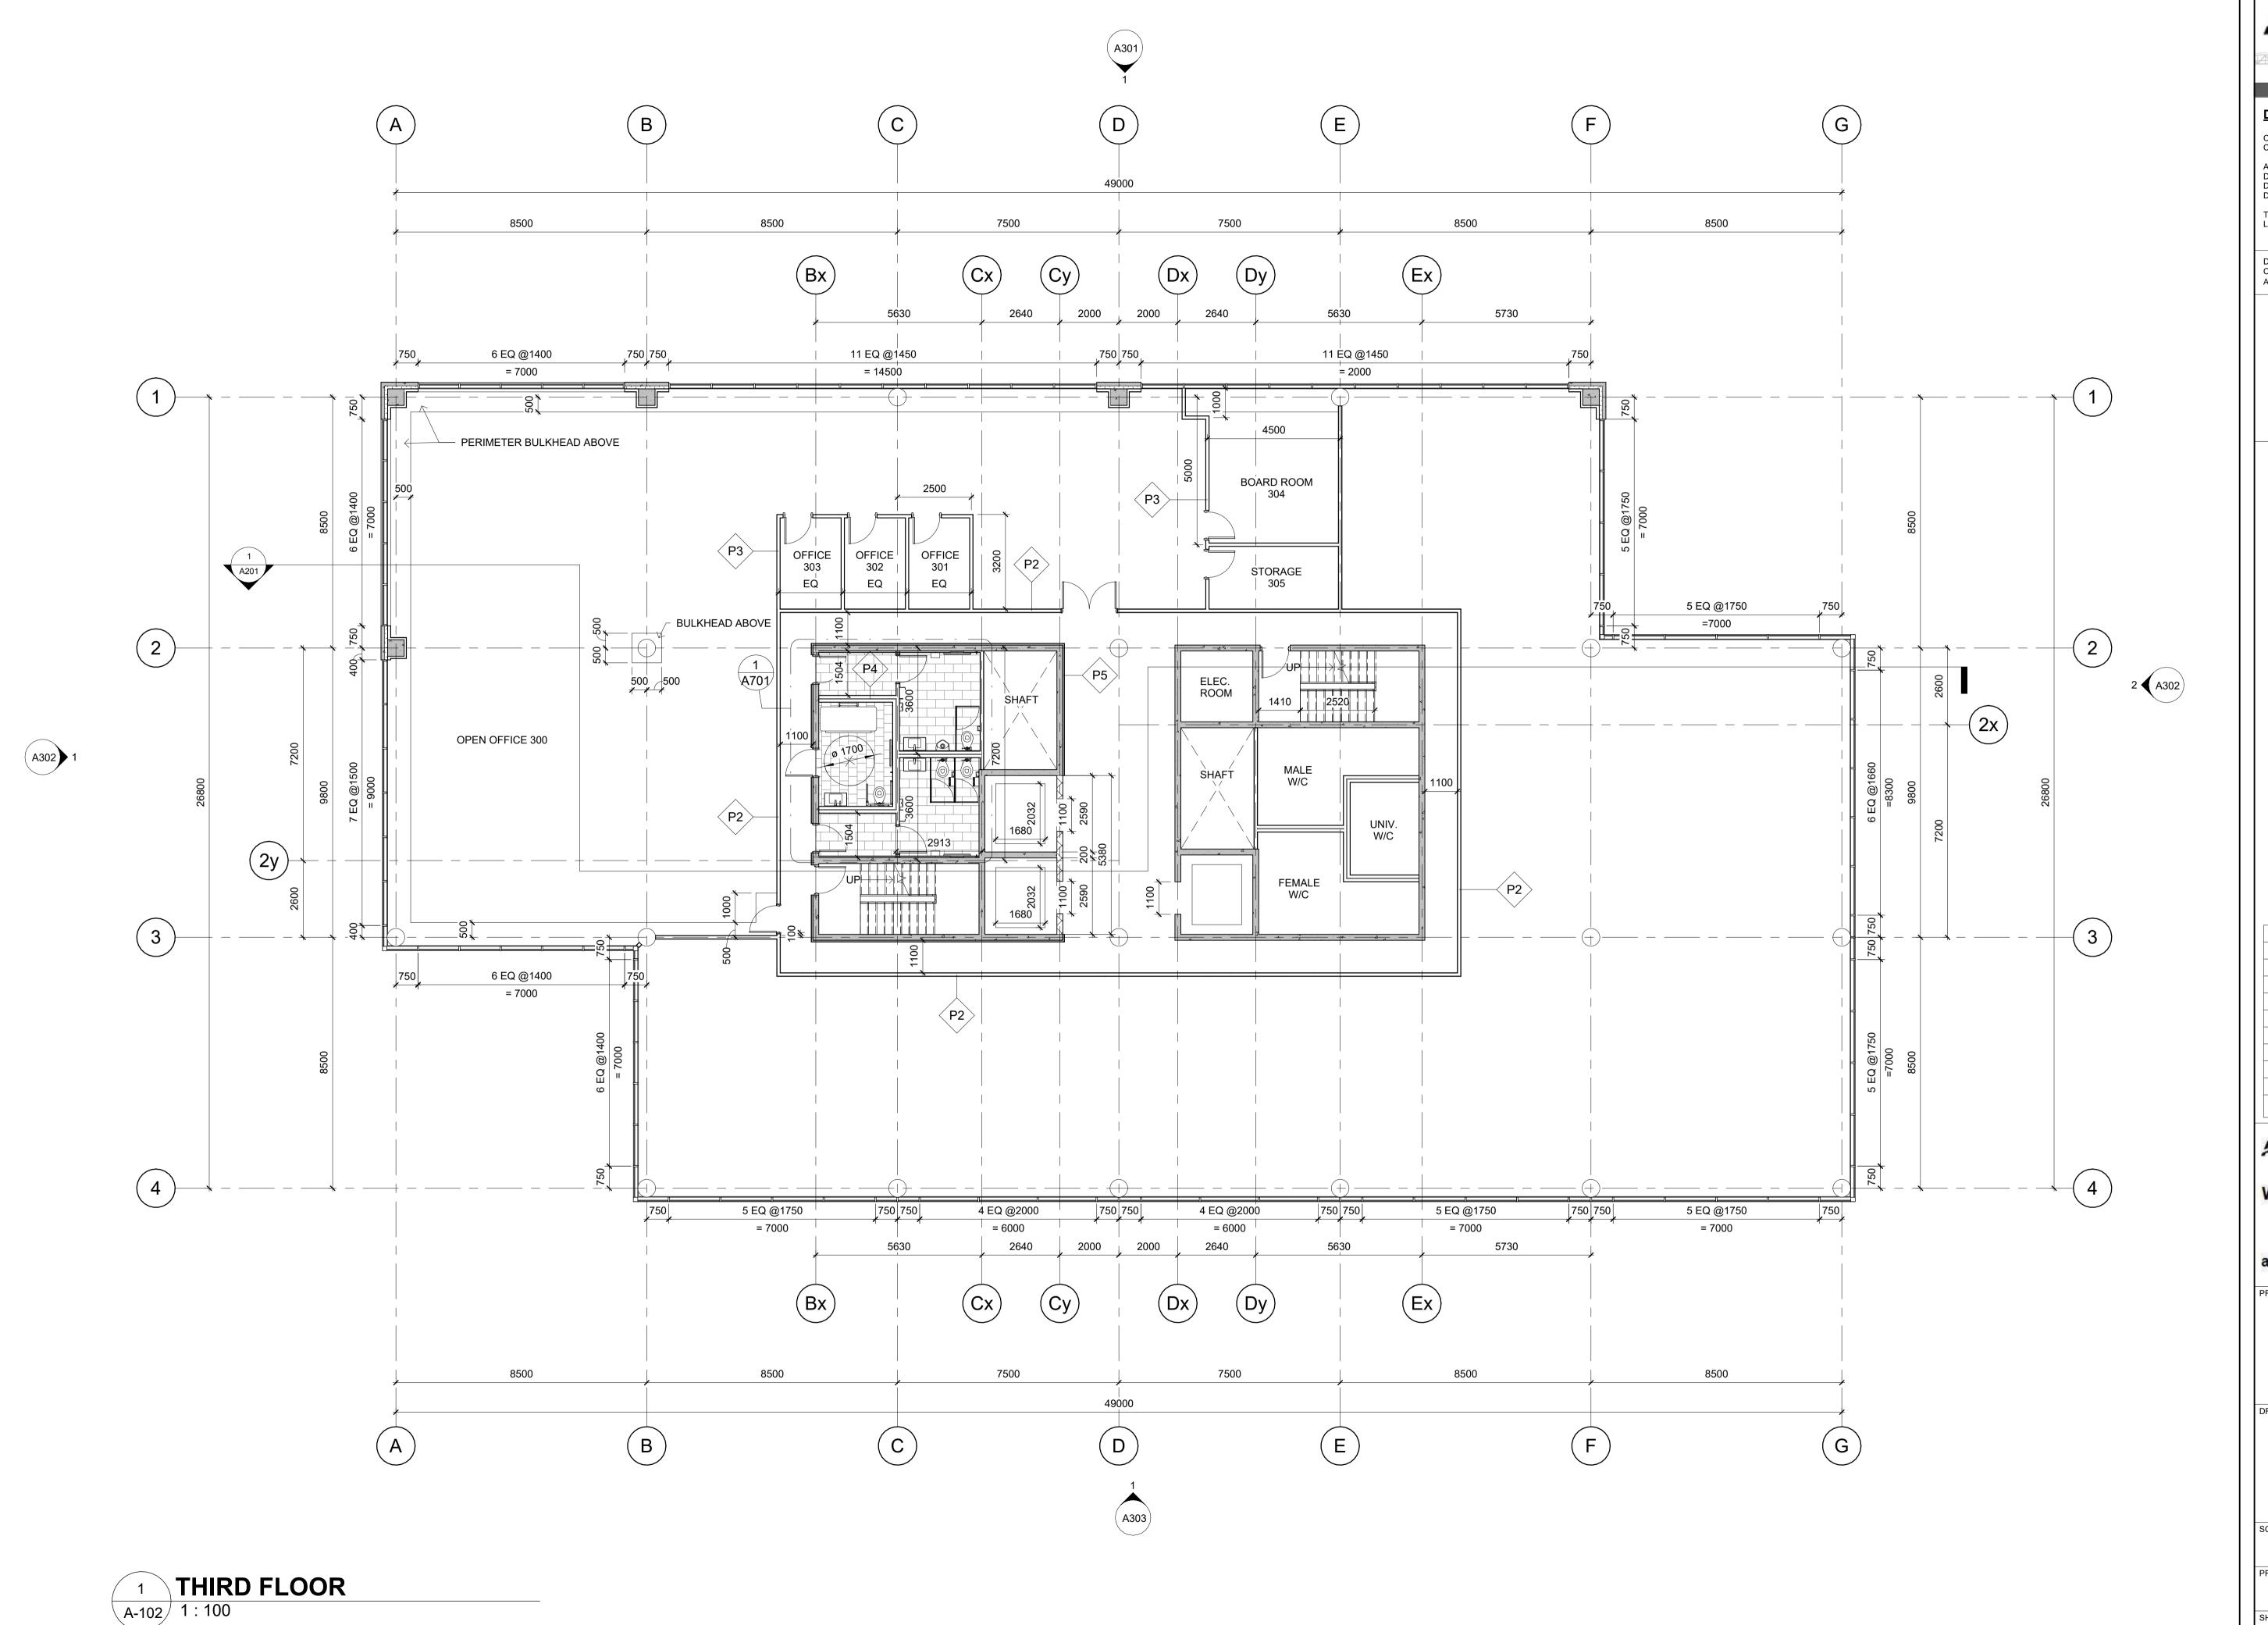
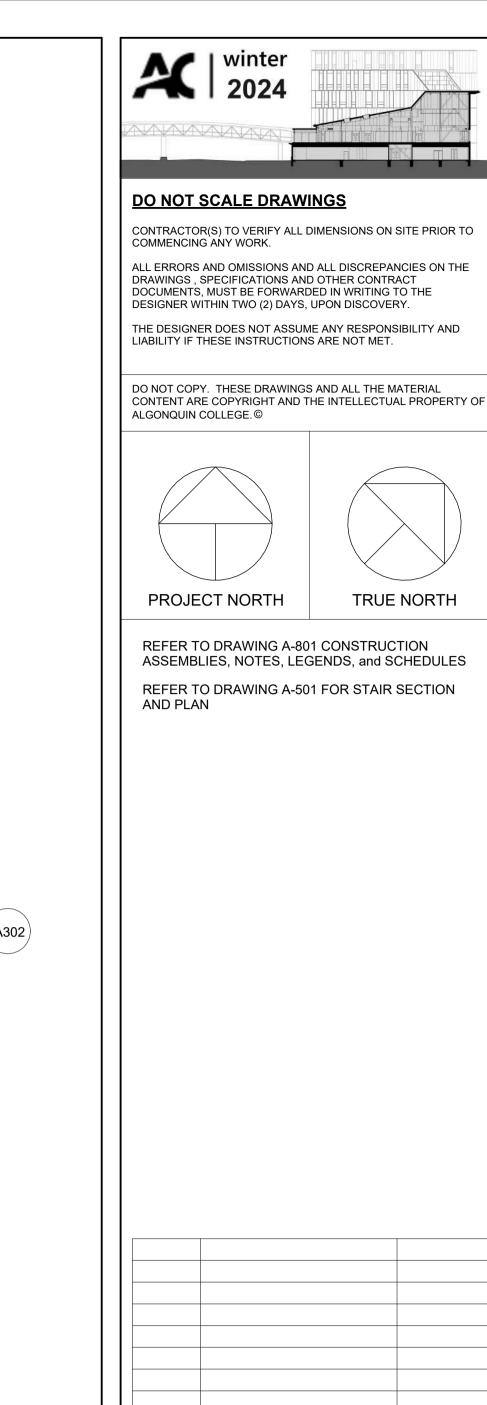
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FINAL SUBMISSION 10/04/2024

Date

WORKING

01

DRAWINGS IV

architectural technician

PROJECT TITLE:

HYDRO ONE - SOUTHWESTERN ONTARIO REGION ADMINISTRATION BUILDING

DRAWING TITLE:

THIRD FLOOR


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 1: 100
 10/04/2024

 PROJECT NUMBER:
 DRAWN BY:

 WDIV-W24-02
 JAMIE CHEUNG

SHEET No.:

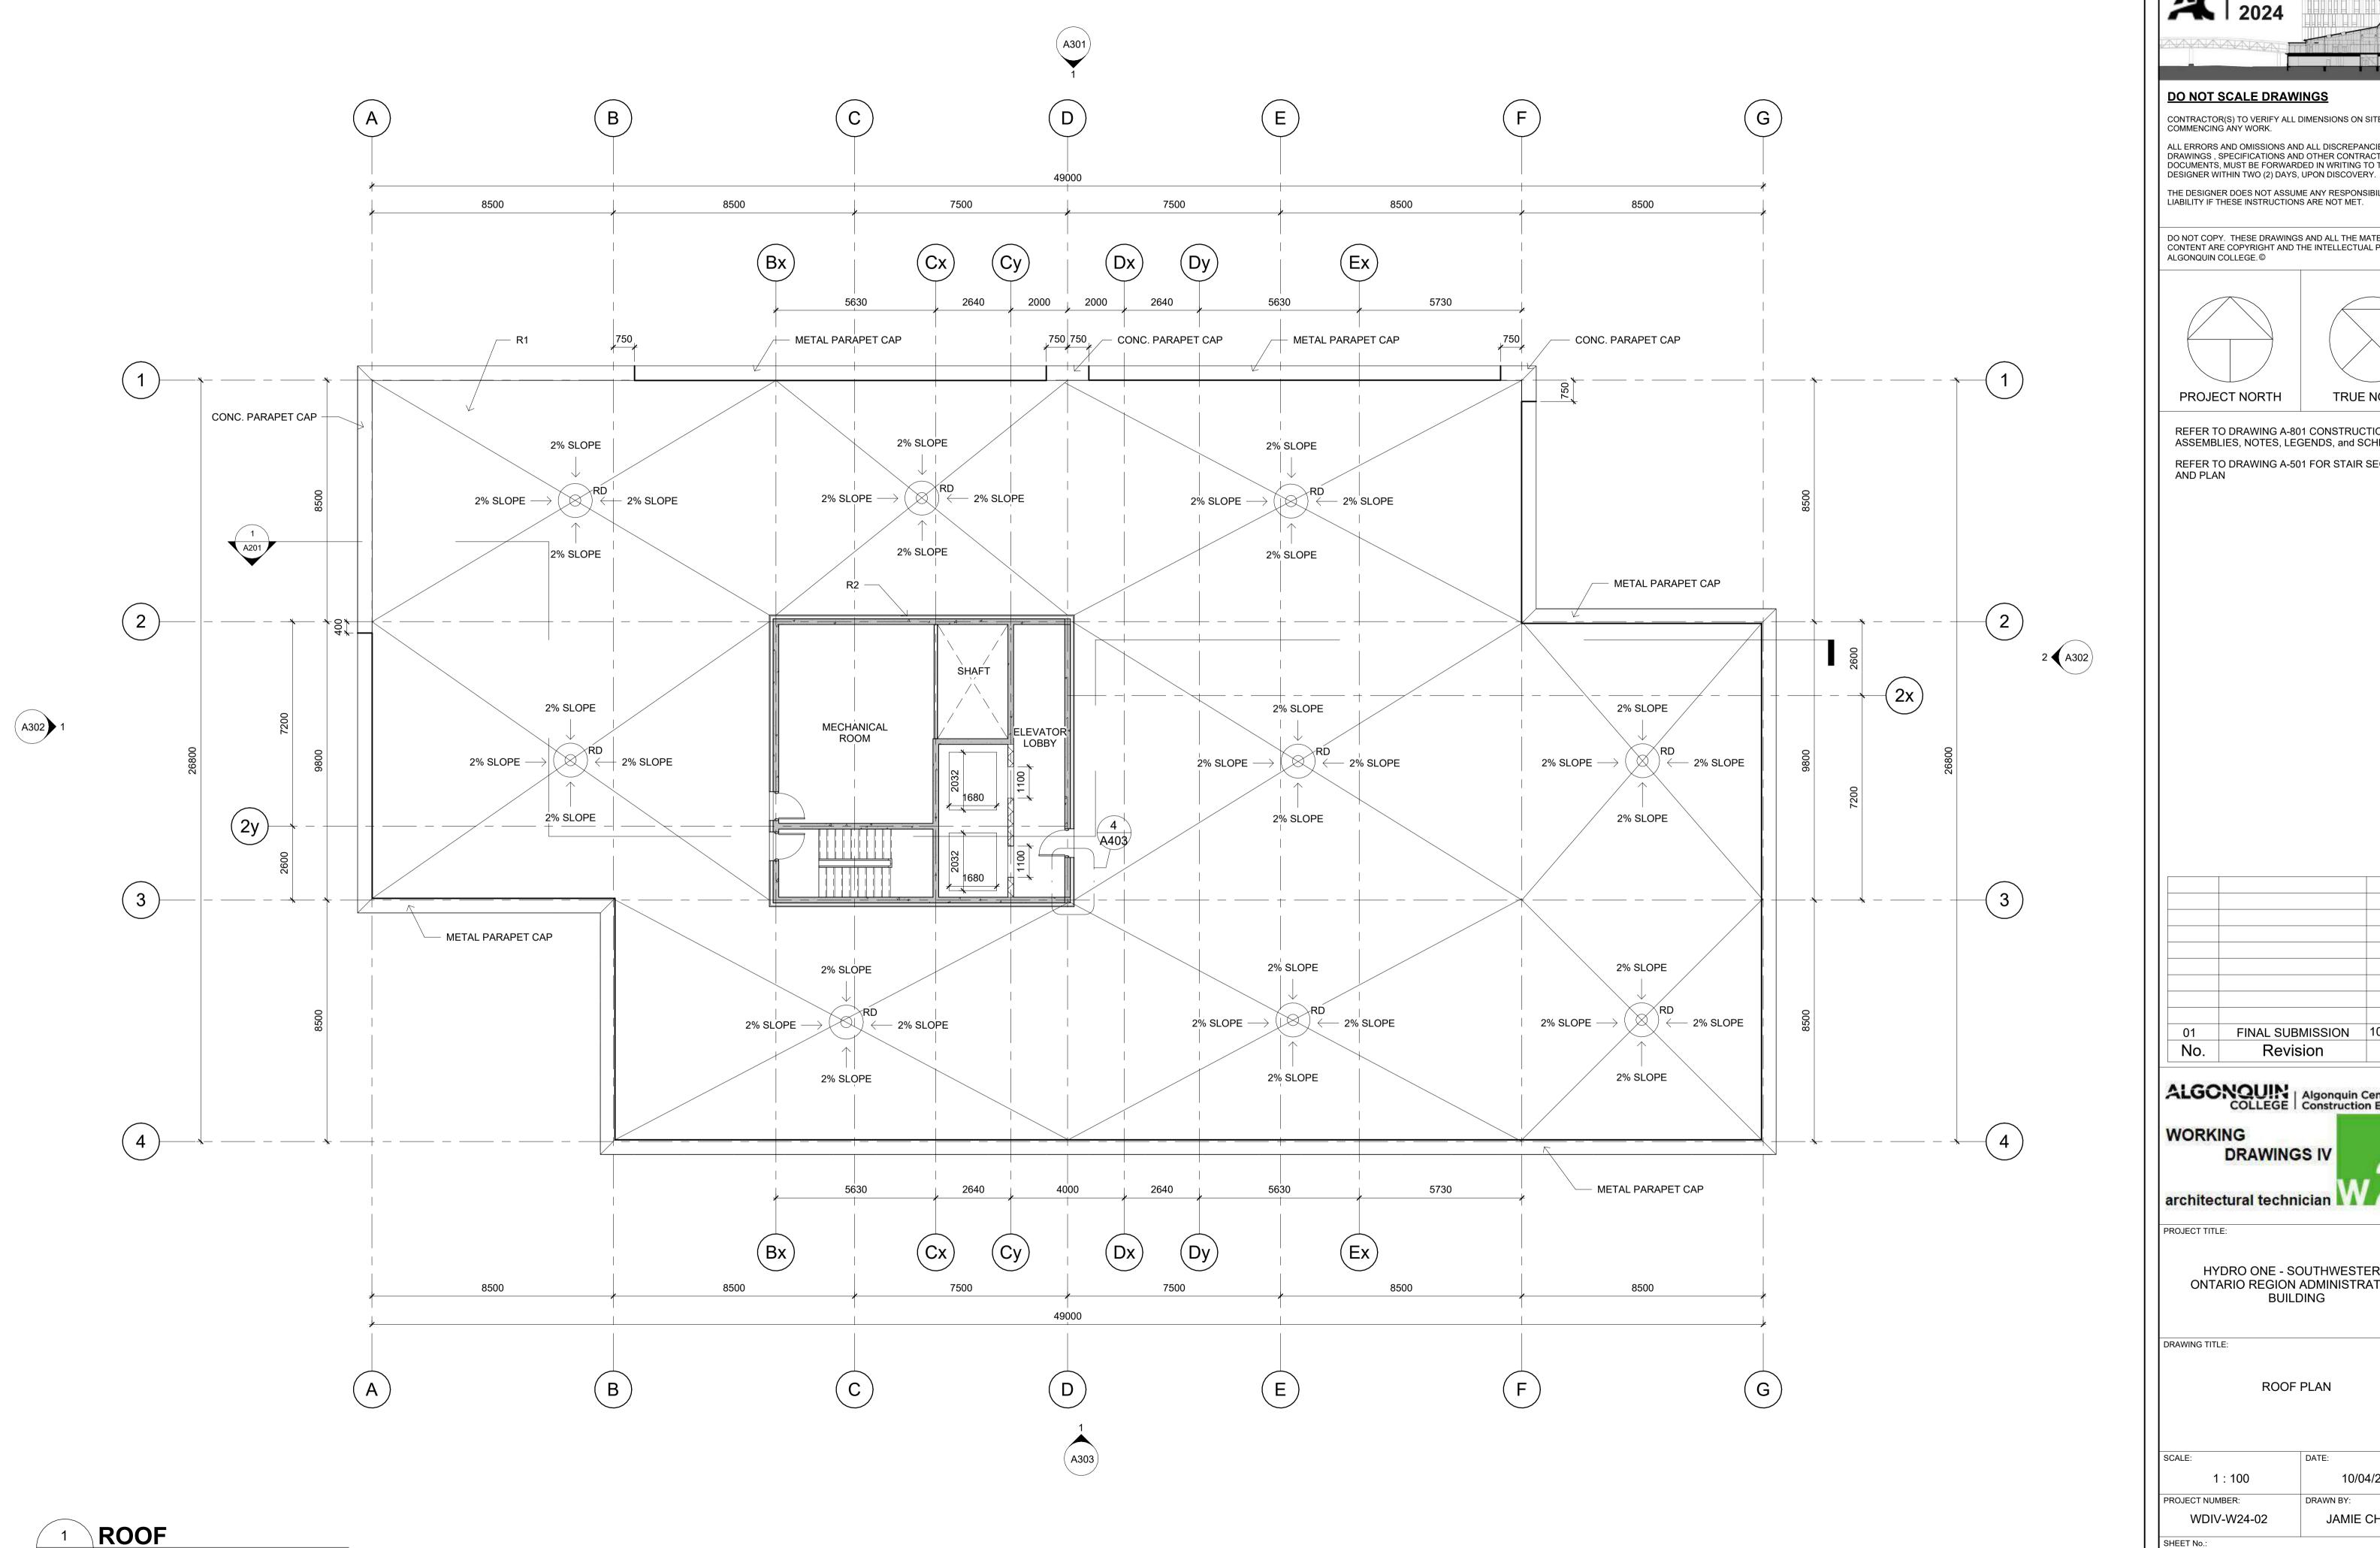


A-103 1:100

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WORKING **DRAWINGS IV**

architectural technician

PROJECT TITLE:

HYDRO ONE - SOUTHWESTERN ONTARIO REGION ADMINISTRATION BUILDING

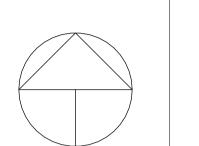DRAWING TITLE:


ROOF PLAN

10/04/2024 1:100


SHEET No.:

WDIV-W24-02

JAMIE CHEUNG

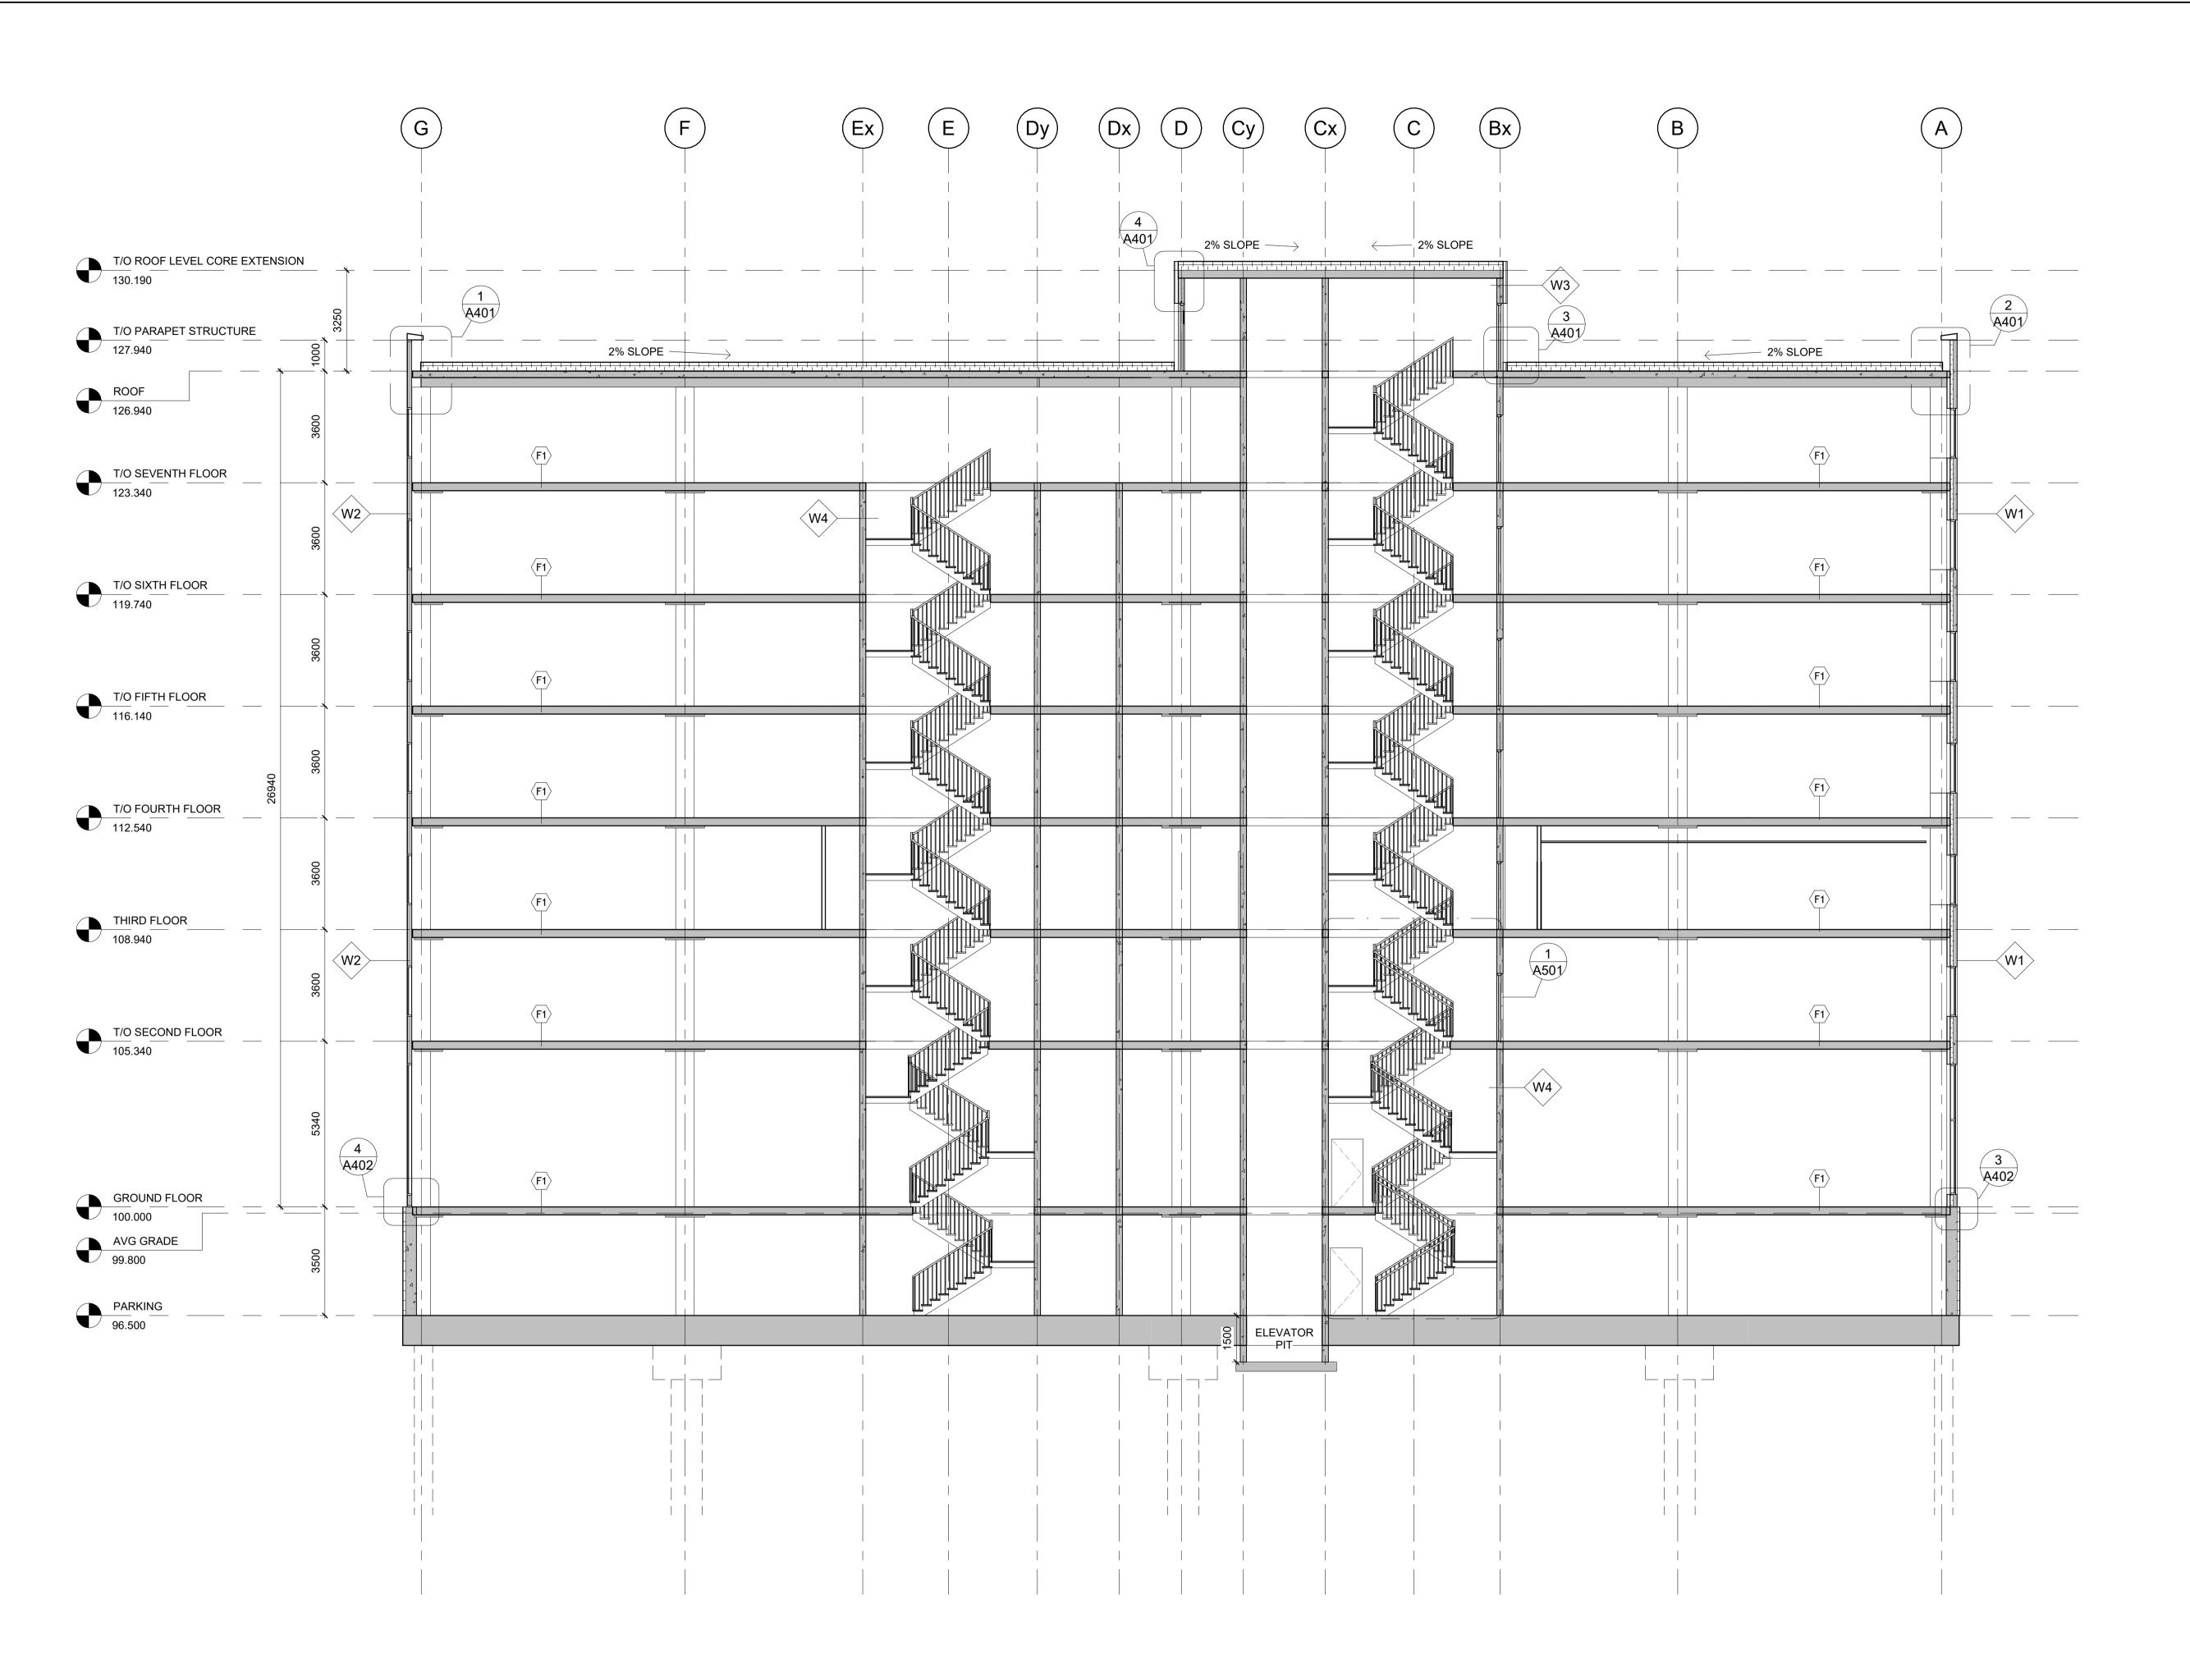

1 BUILDING SECTION
1: 100

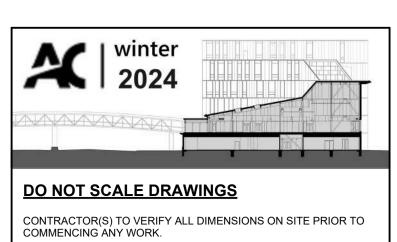

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ASSEMBLIES, NOTES, LEGENDS, and SCHEDULES
REFER TO DRAWING A-403 FOR STAIR SECTION
AND PLAN

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WORKING

DRAWINGS IV

architectural technician

PROJECT TITLE:

HYDRO ONE - SOUTHWESTERN ONTARIO REGION ADMINISTRATION BUILDING

DRAWING TITLE:

BUILDING SECTION

10/04/2024

JAMIE CHEUNG


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1:100

PROJECT NUMBER:

WDIV-W24-02

SHEET No.:

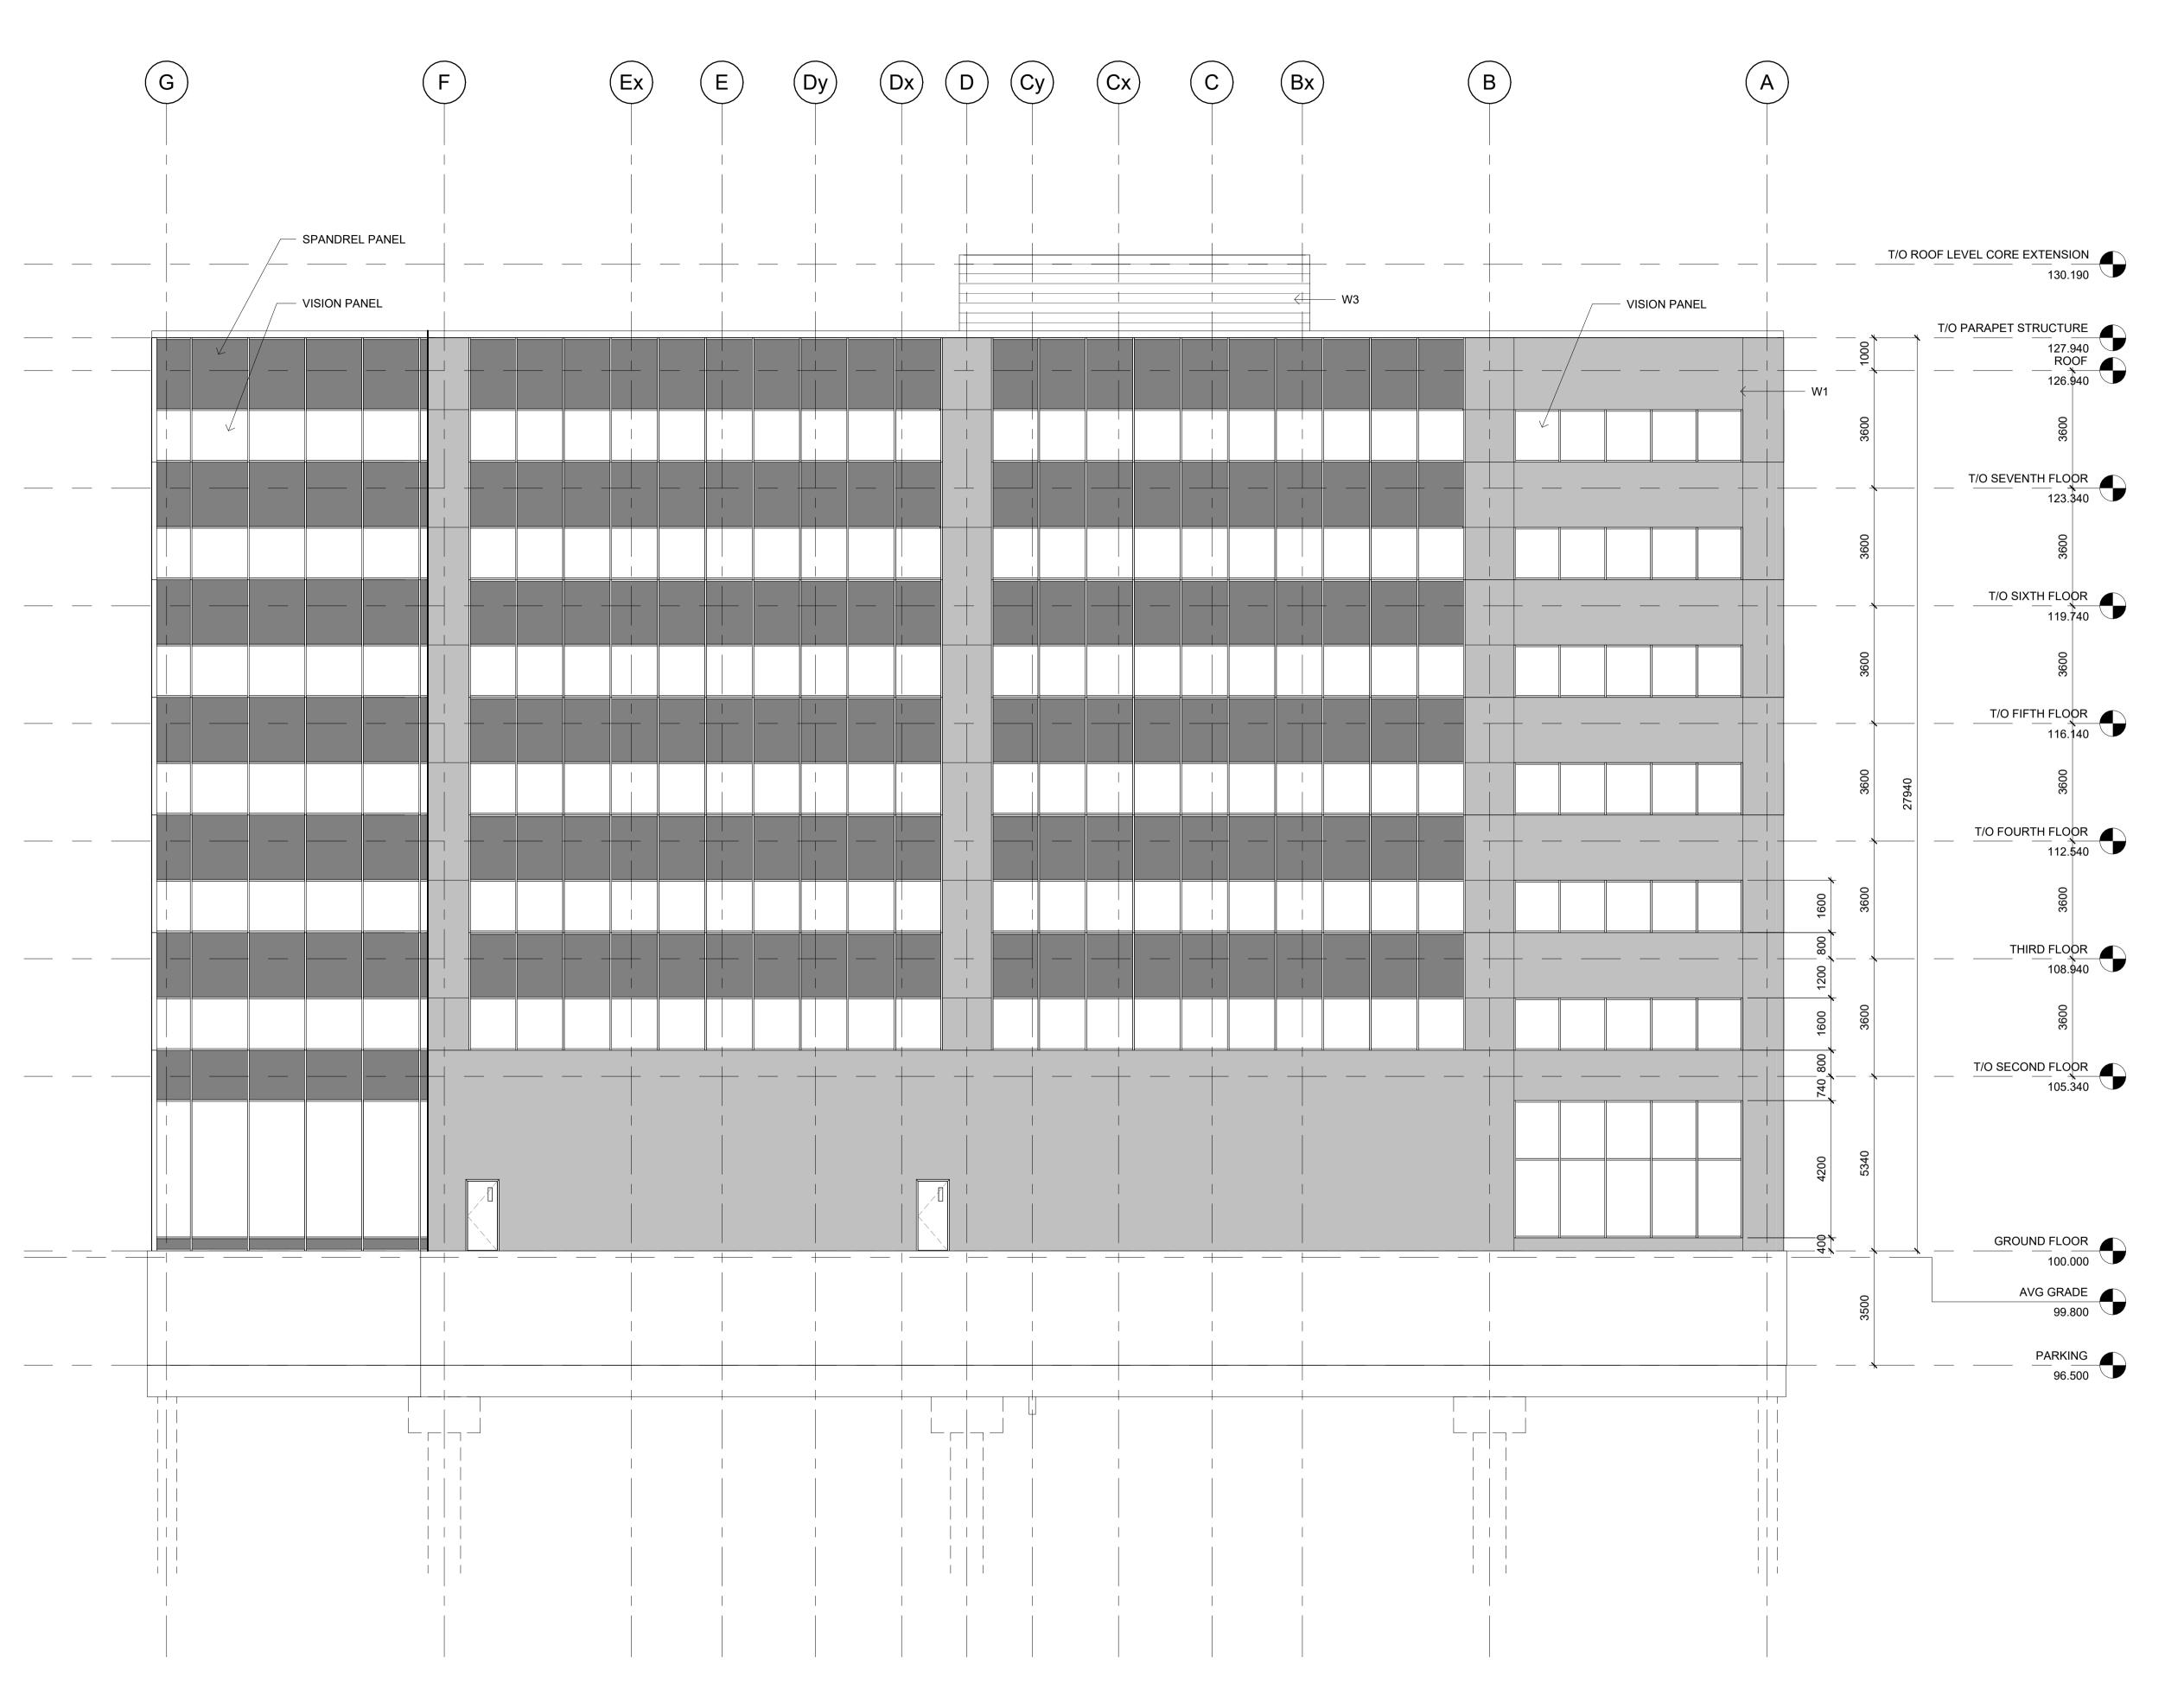

North A-301 1:100

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WORKING **DRAWINGS IV**

architectural technician

HYDRO ONE - SOUTHWESTERN ONTARIO REGION ADMINISTRATION BUILDING

DRAWING TITLE:

PROJECT TITLE:


NORTH ELEVATION

10/04/2024 1:100 PROJECT NUMBER:

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South A-303/1 : 100



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WORKING

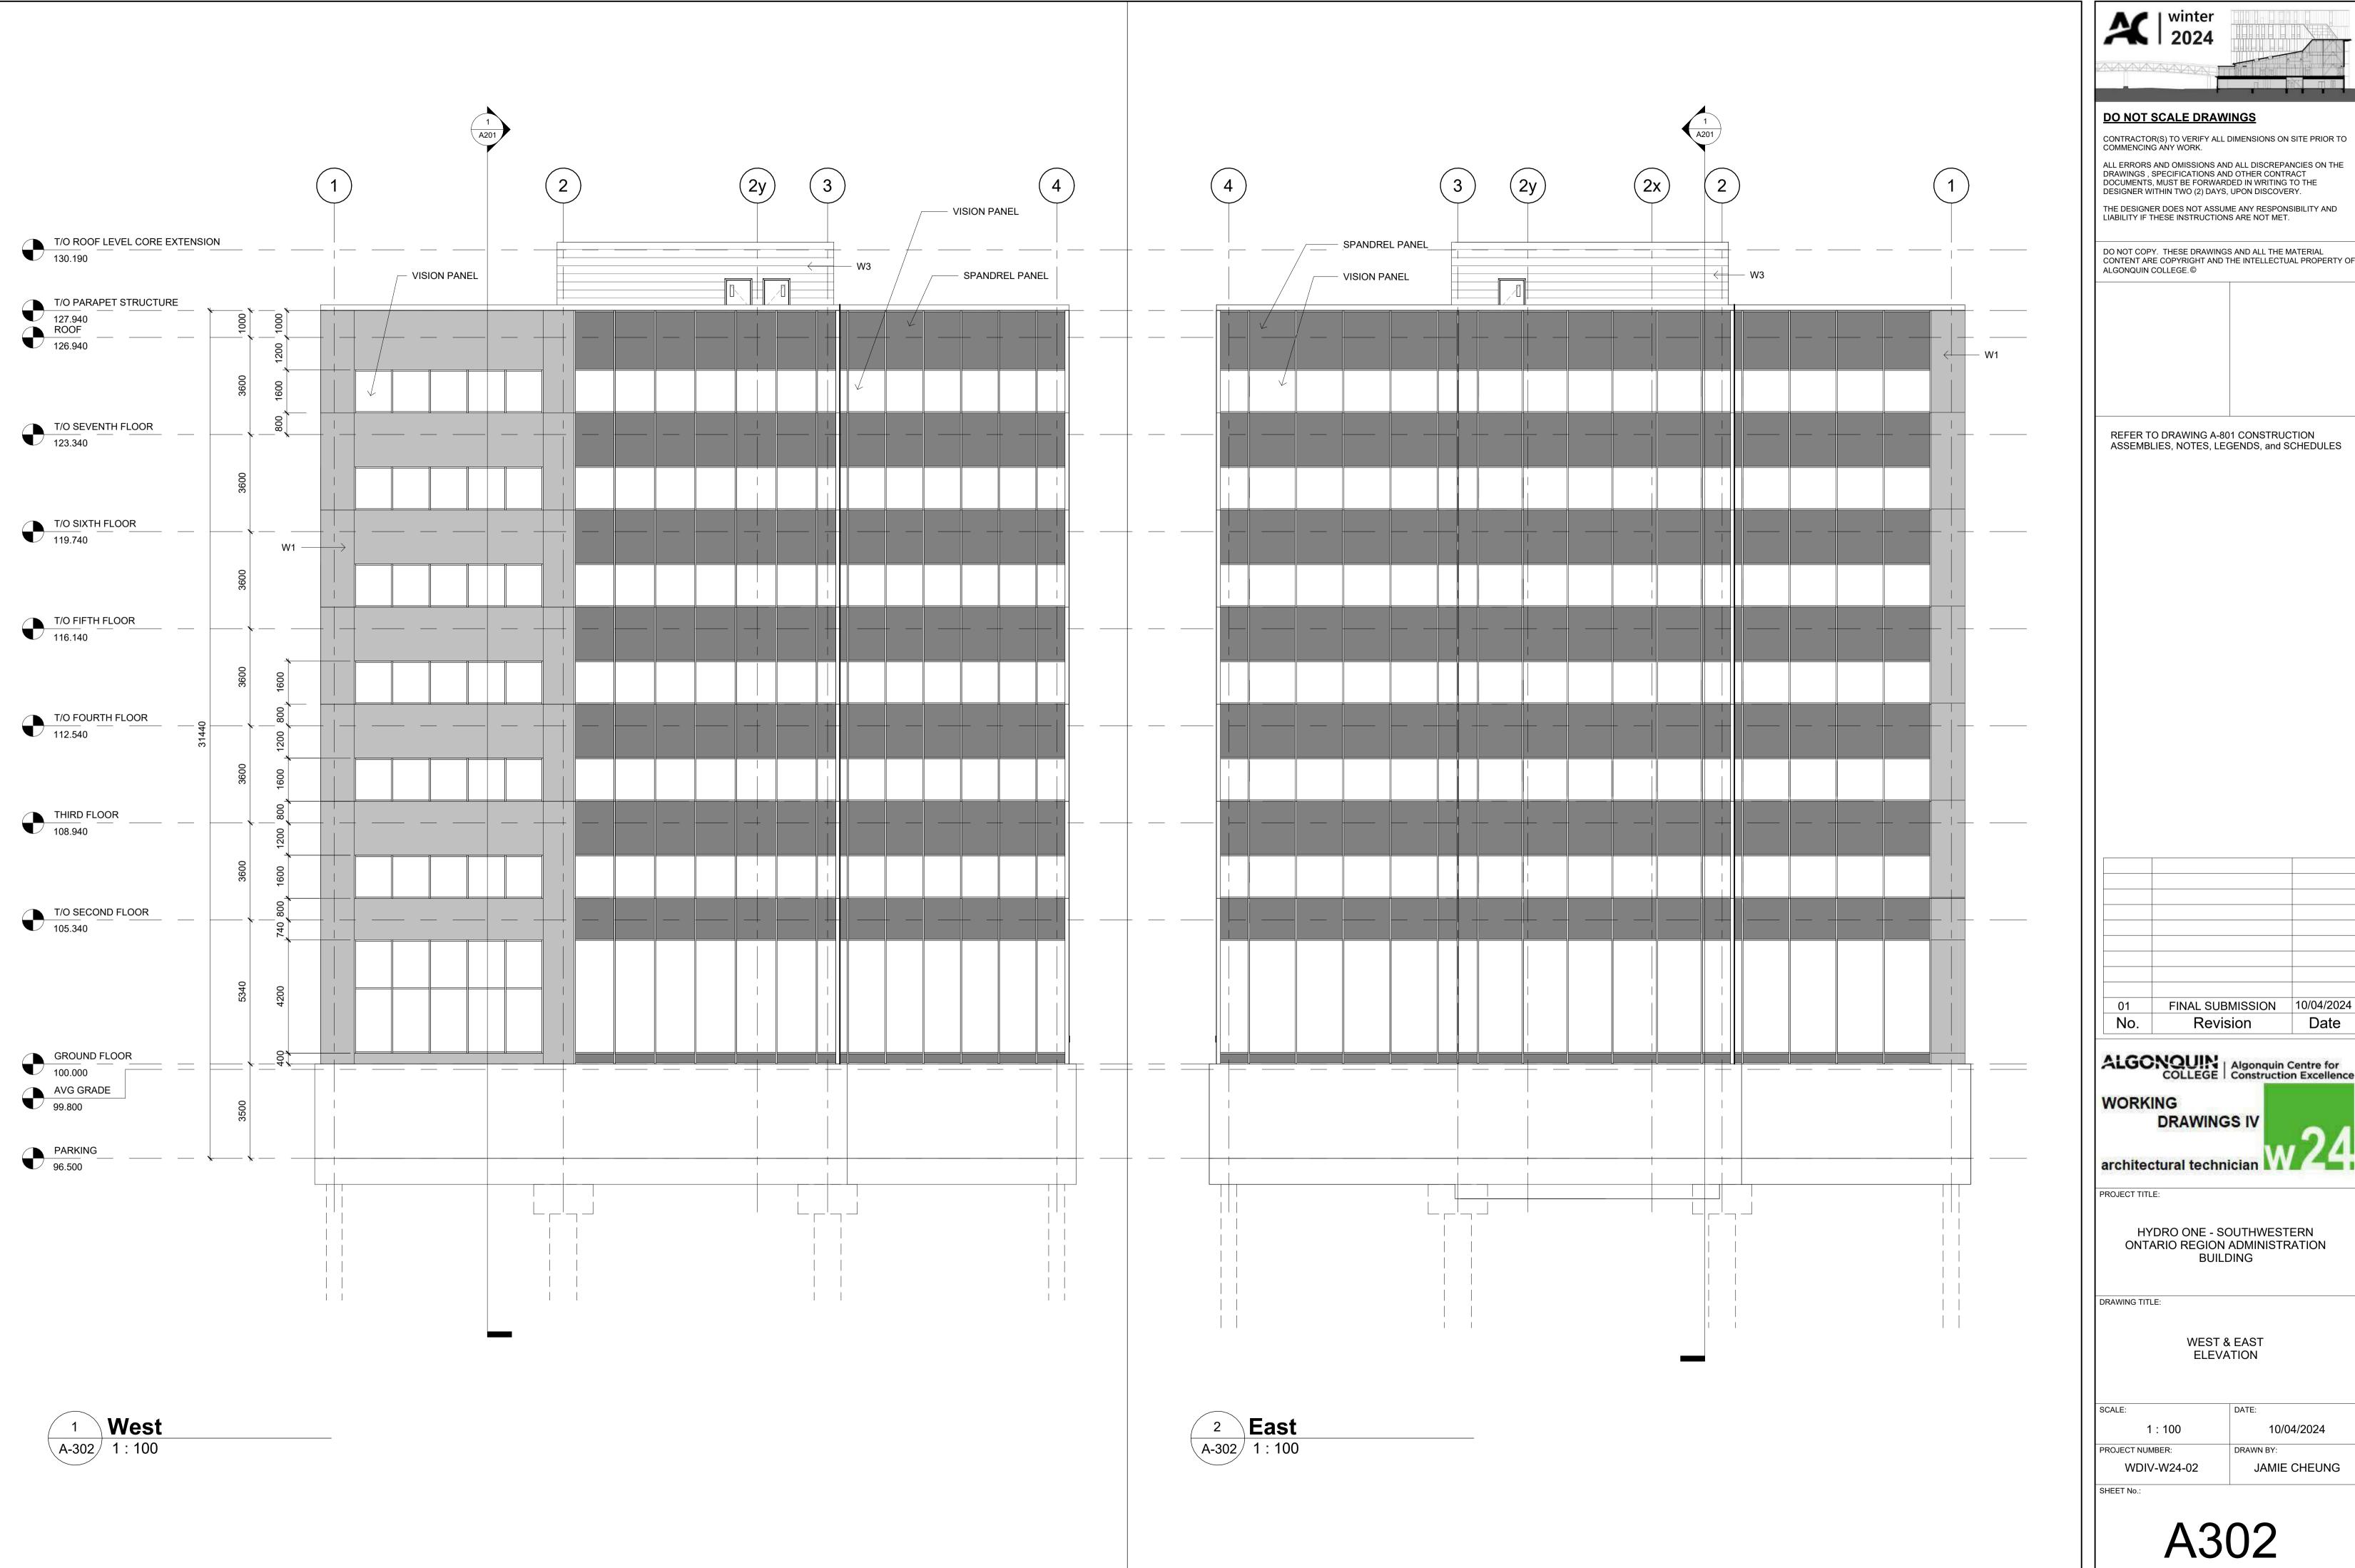DRAWINGS IV

architectural technician

PROJECT TITLE:

HYDRO ONE - SOUTHWESTERN ONTARIO REGION ADMINISTRATION BUILDING

DRAWING TITLE:


SOUTH ELEVATION

SCALE: 1:100 PROJECT NUMBER:

JAMIE CHEUNG WDIV-W24-02

10/04/2024

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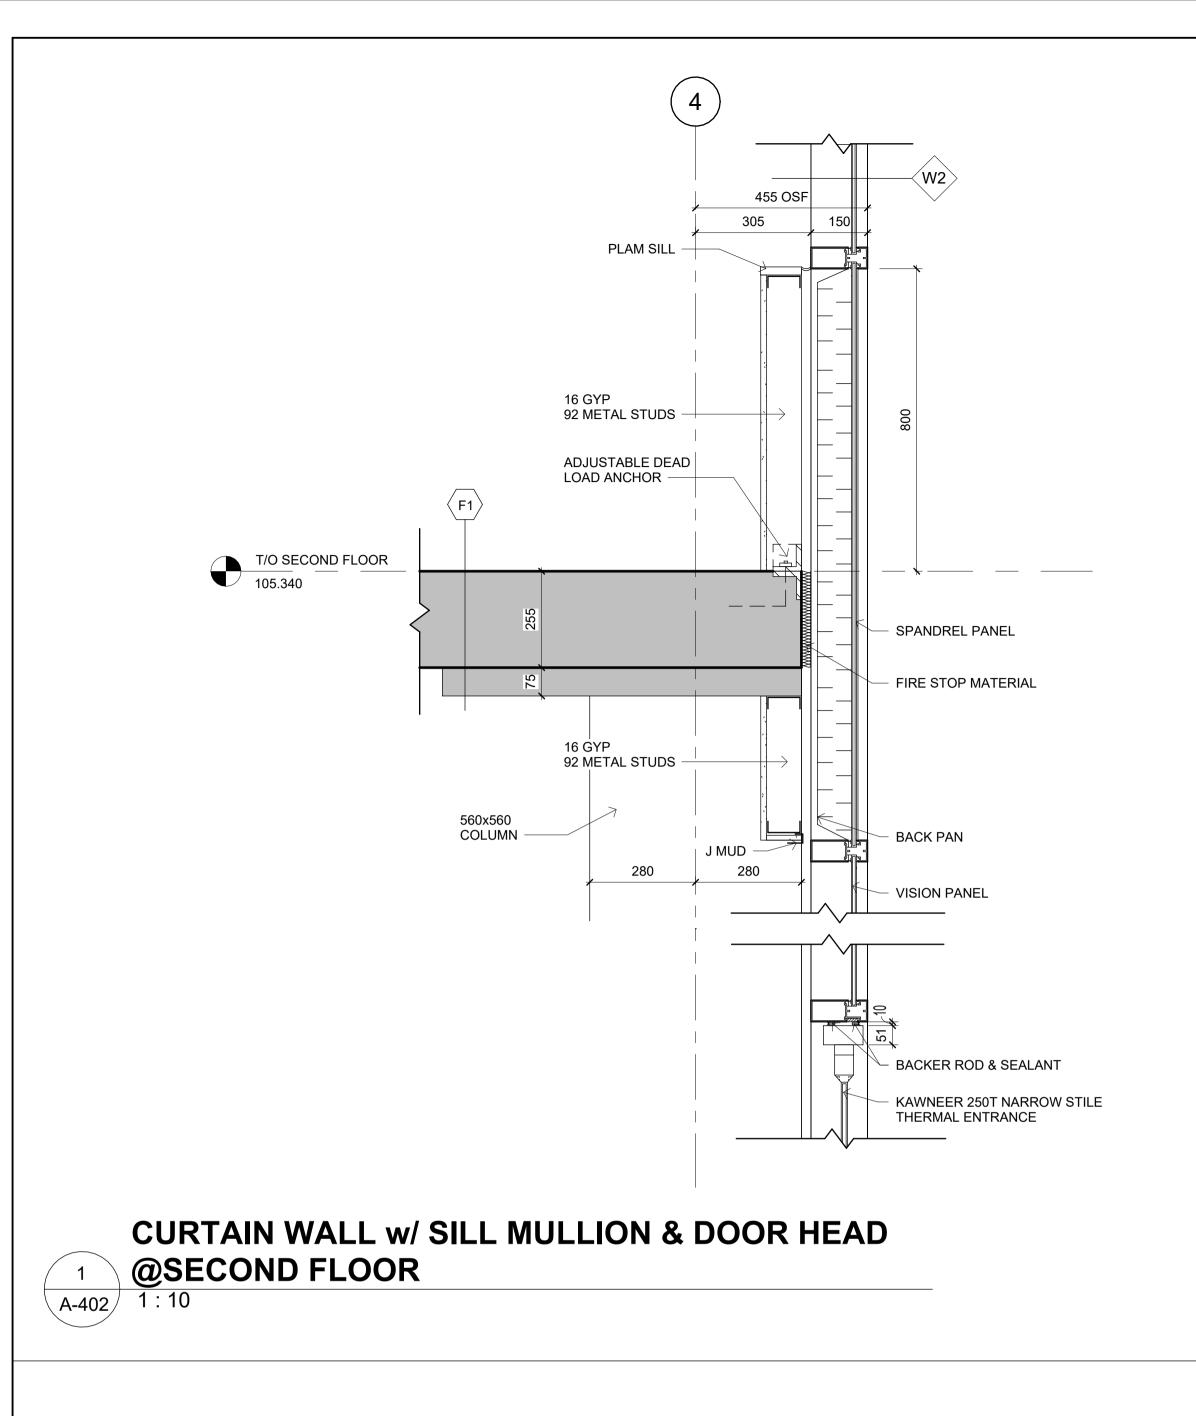
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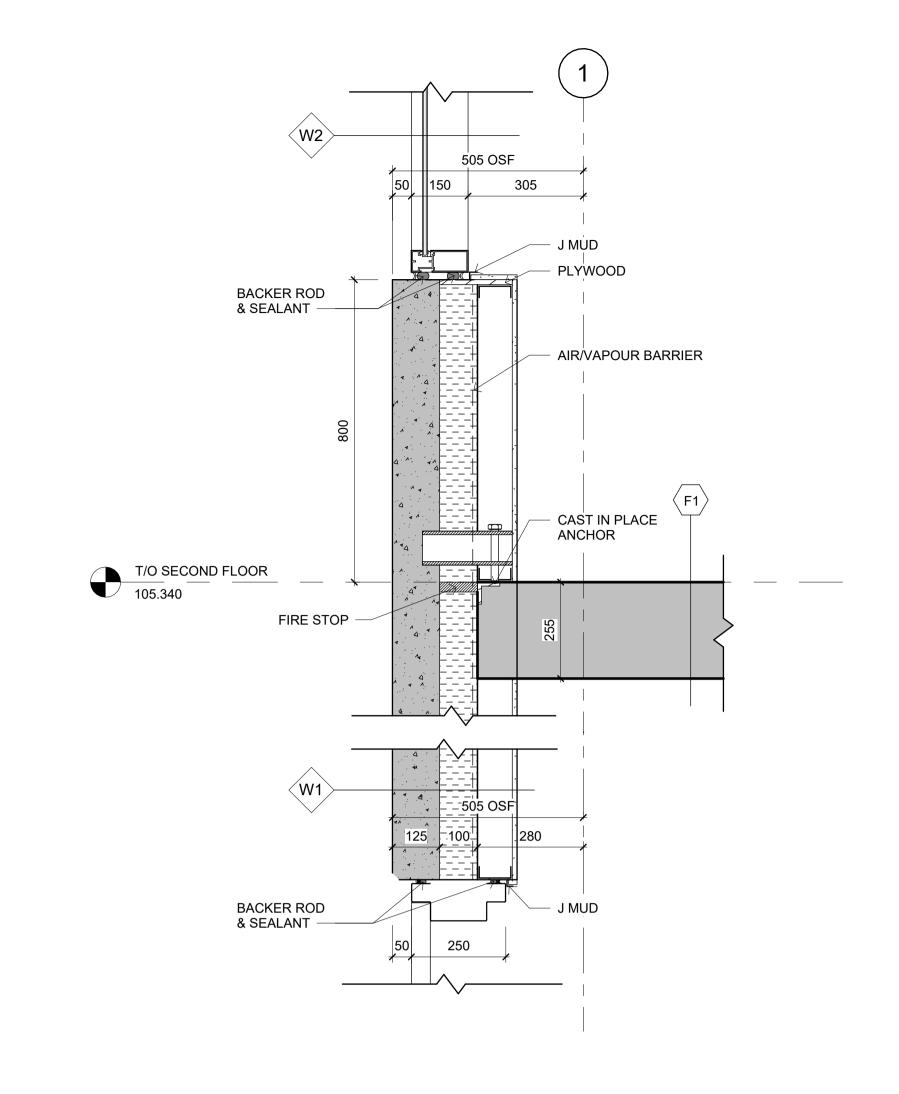
HYDRO ONE - SOUTHWESTERN ONTARIO REGION ADMINISTRATION BUILDING

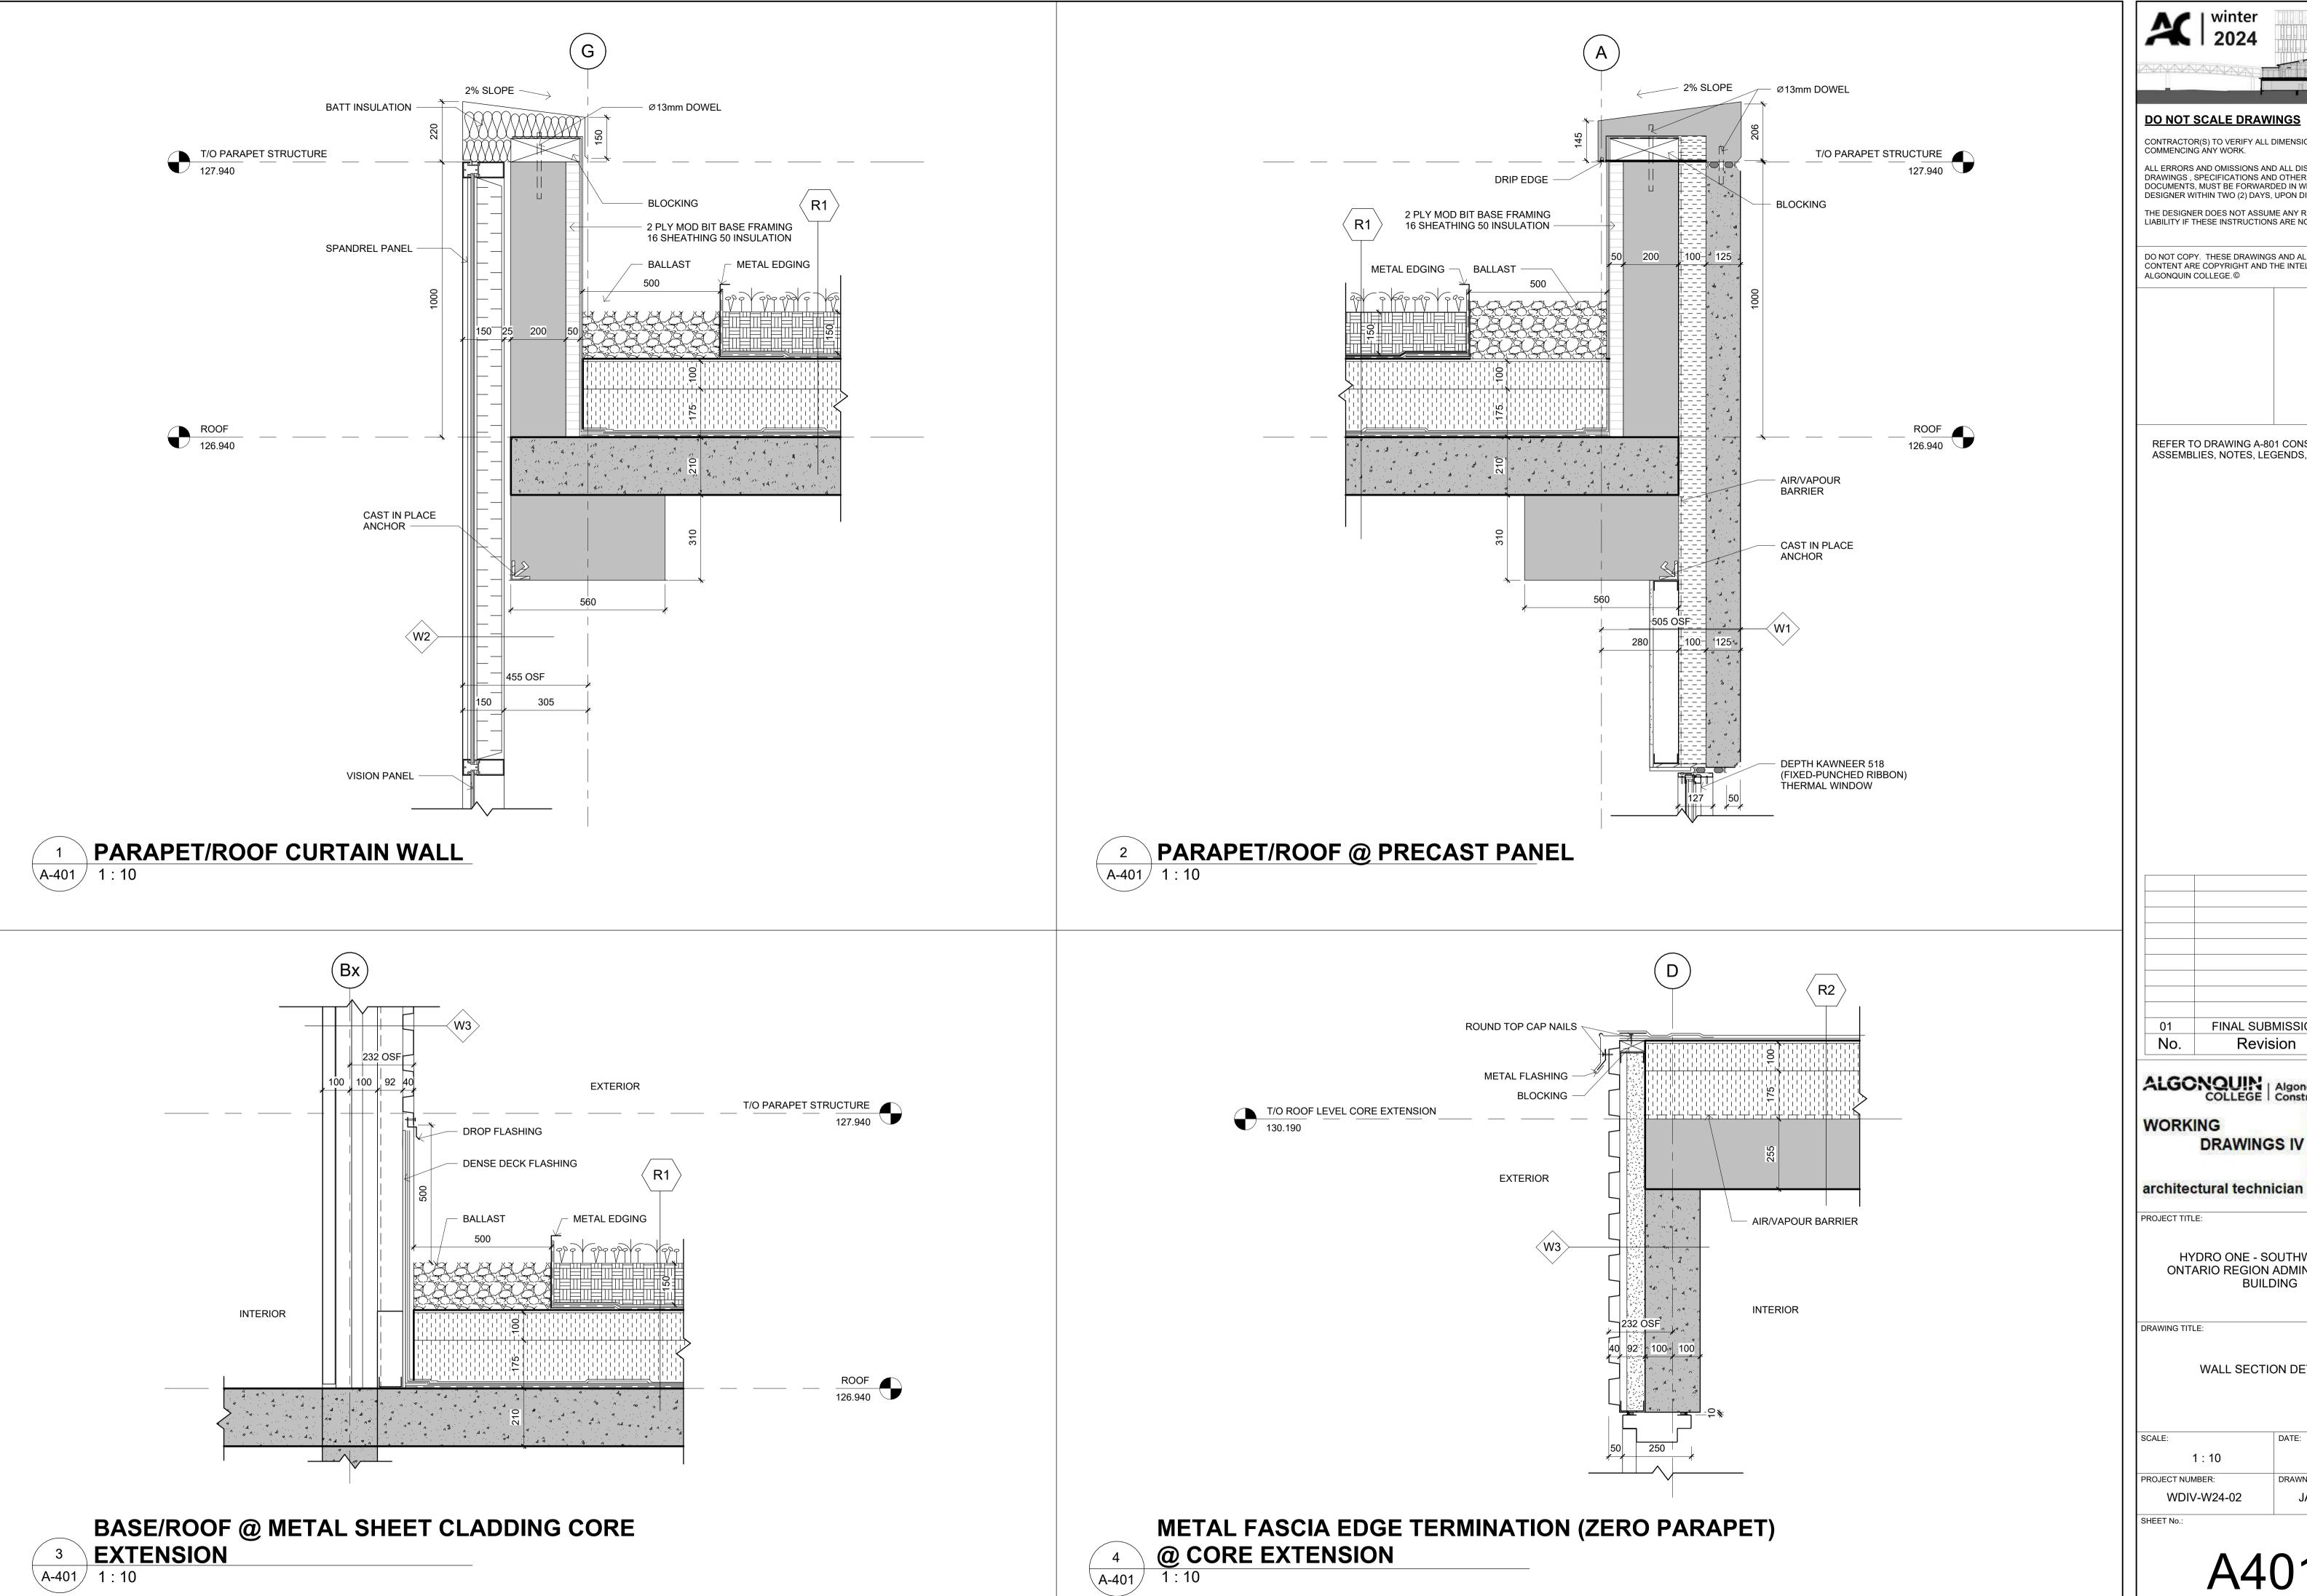WALL SECTION DETAILS

1:10

10/04/2024 JAMIE CHEUNG





PRECAST PANEL w/ WINDOW SILL & DOOR HEAD @ SECOND FLOOR


A-402 1 : 10

DEPTH KAWNEER 518 (FIXED-PUNCHED RIBBON) BACKER ROD & SEALANT GROUND FLOOR 100.000 PRE FINISH METAL FINISHED AVG GRADE 99.800 505 OSF 155 350 16 SHEATHING **75 INSULATION**

(G)VISION PANEL -SPANDREL PANEL - PLAM SILL - 16 GYP 92 METAL STUDS BACKER ROD & SEALANT GROUND FLOOR
100.000 PRE METAL FLASHING 505 OSF 350 16 SHEATHING 75 INSULATION -

BASE/FOUNDATION @SILL MULLION

A-402 1 : 10

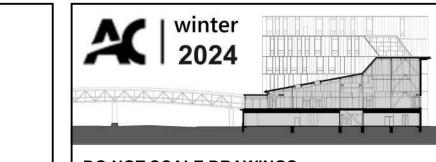

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WORKING **DRAWINGS IV**

PROJECT TITLE:

HYDRO ONE - SOUTHWESTERN ONTARIO REGION ADMINISTRATION BUILDING

DRAWING TITLE:

WALL SECTION DETAILS


10/04/2024 1:10 PROJECT NUMBER:

SHEET No.

WDIV-W24-02

JAMIE CHEUNG

BASE/FOUNDATION @PRECAST PANEL A-402 1:10

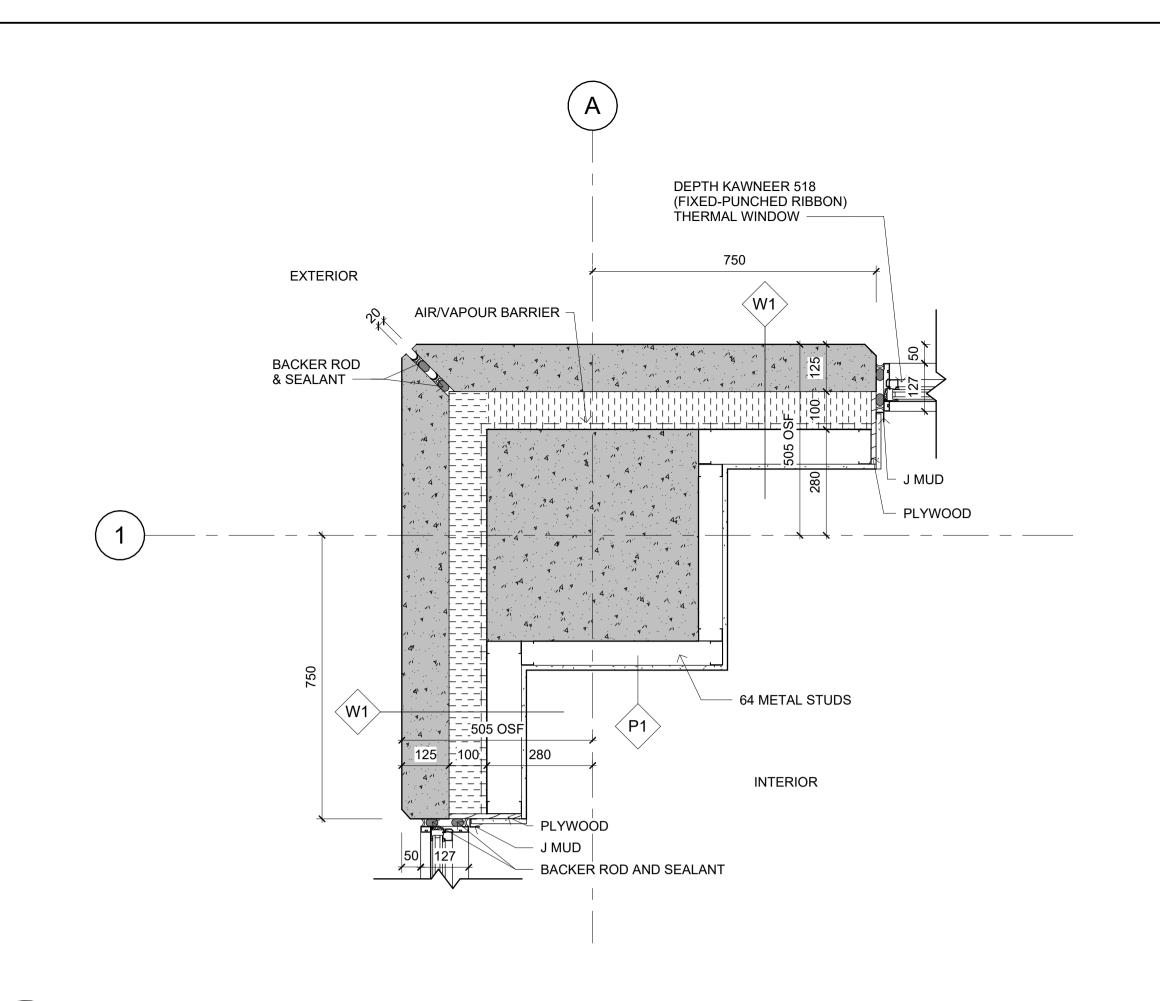



PRECAST PANEL SYSTEM OUTSIDE CORNER


A-403 1:10

COVER


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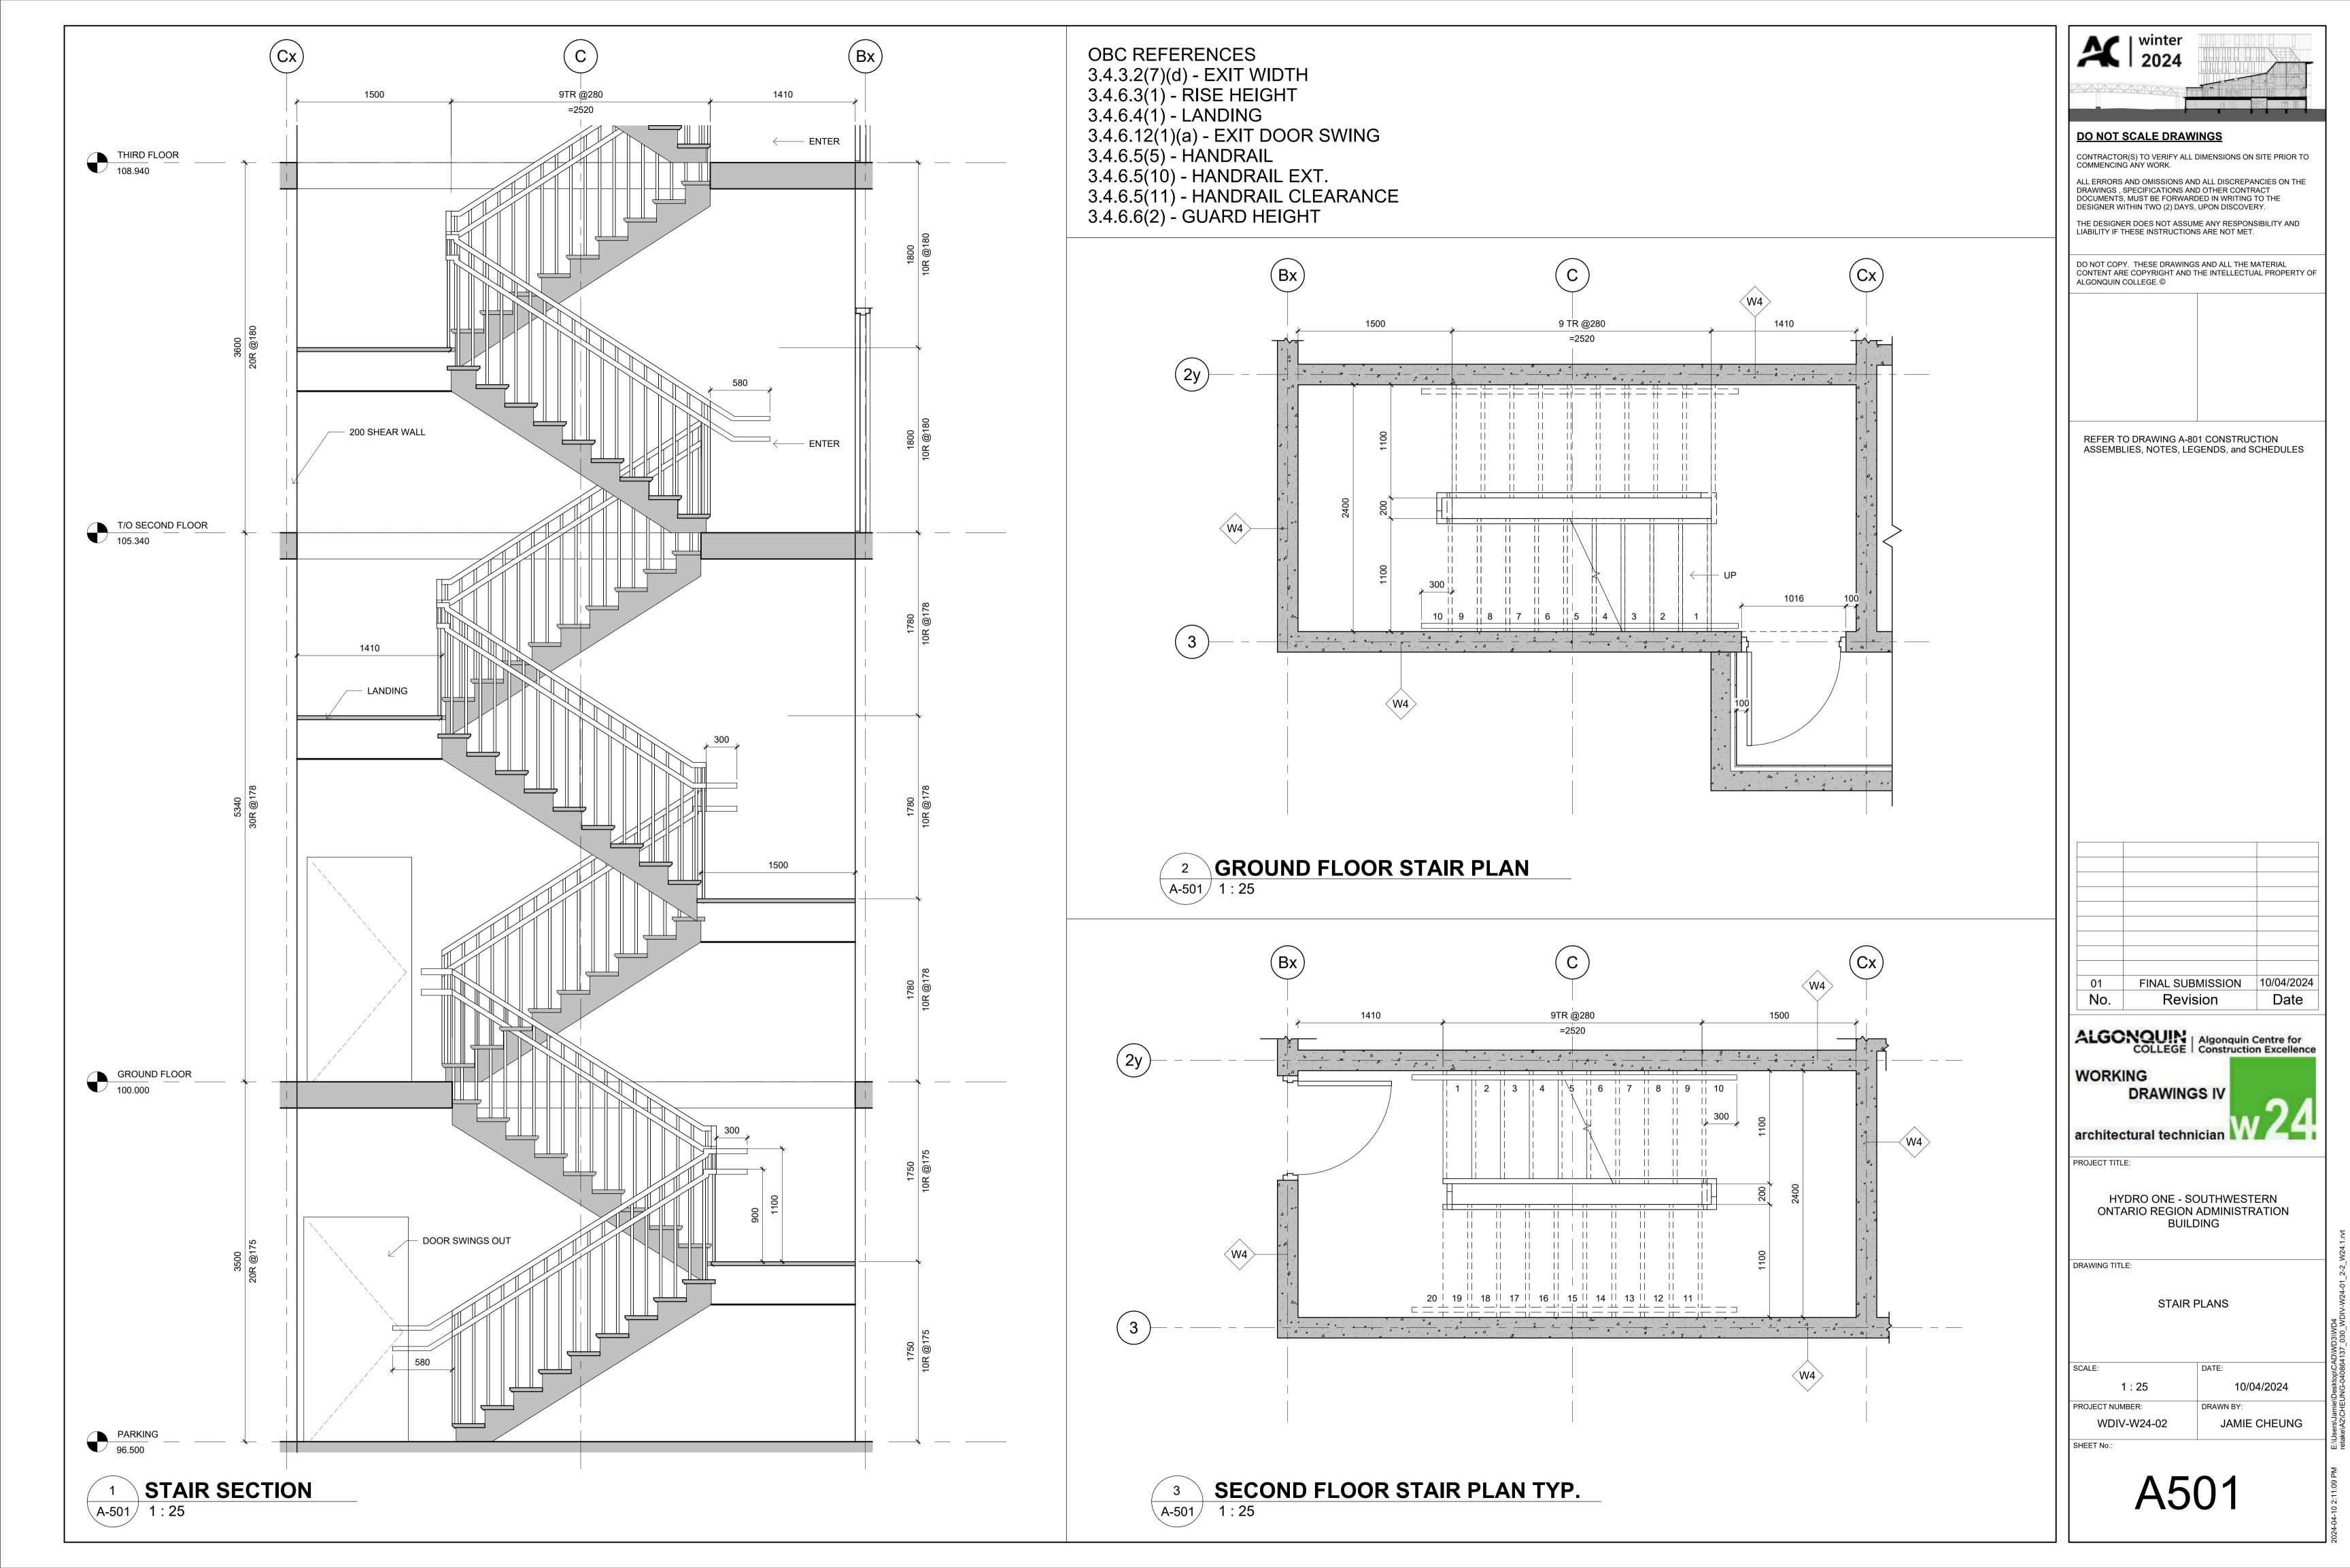


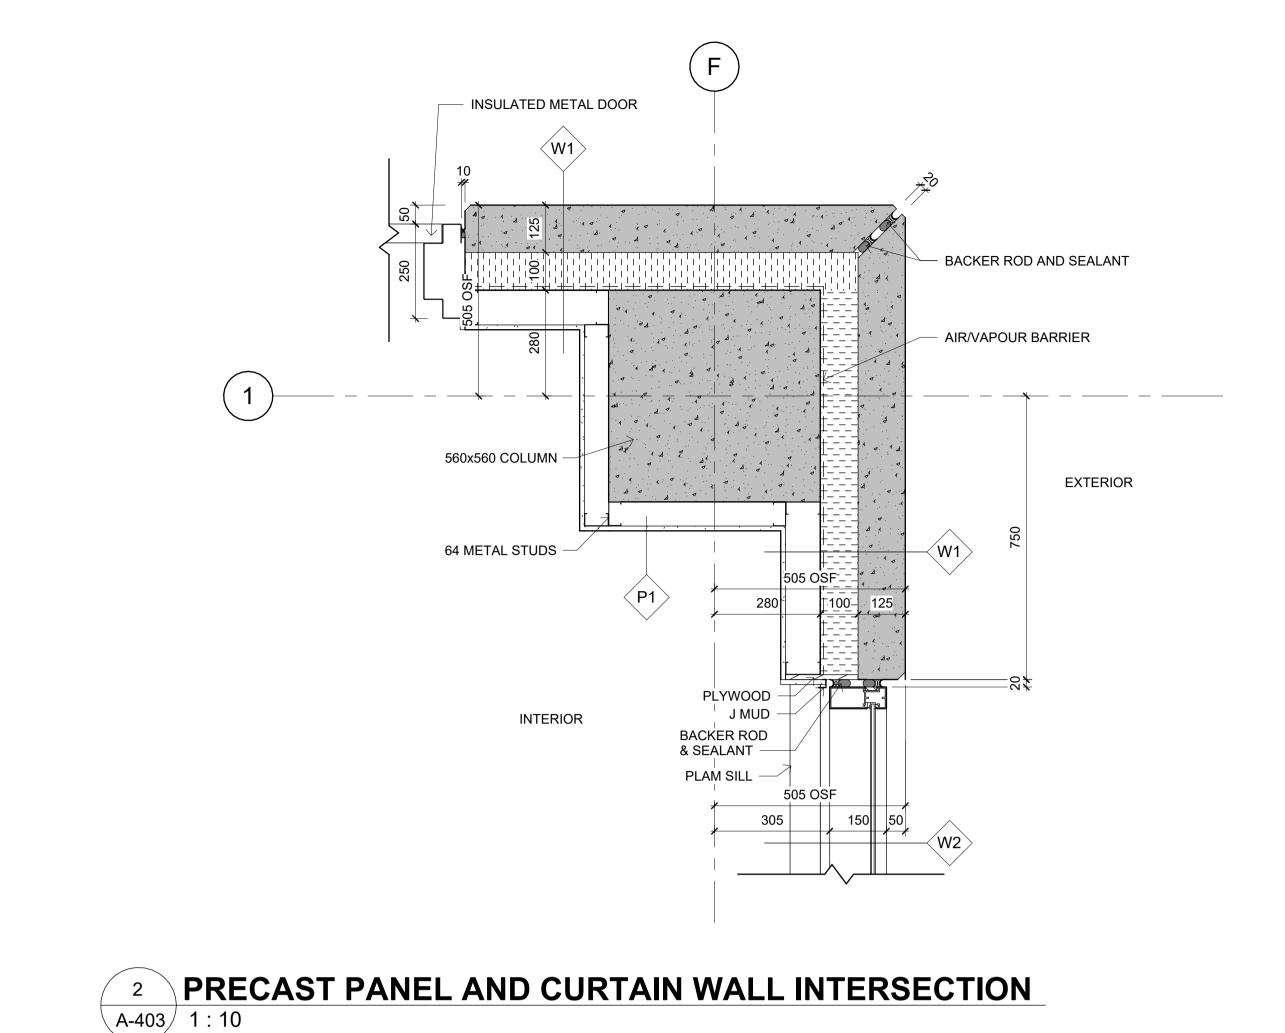
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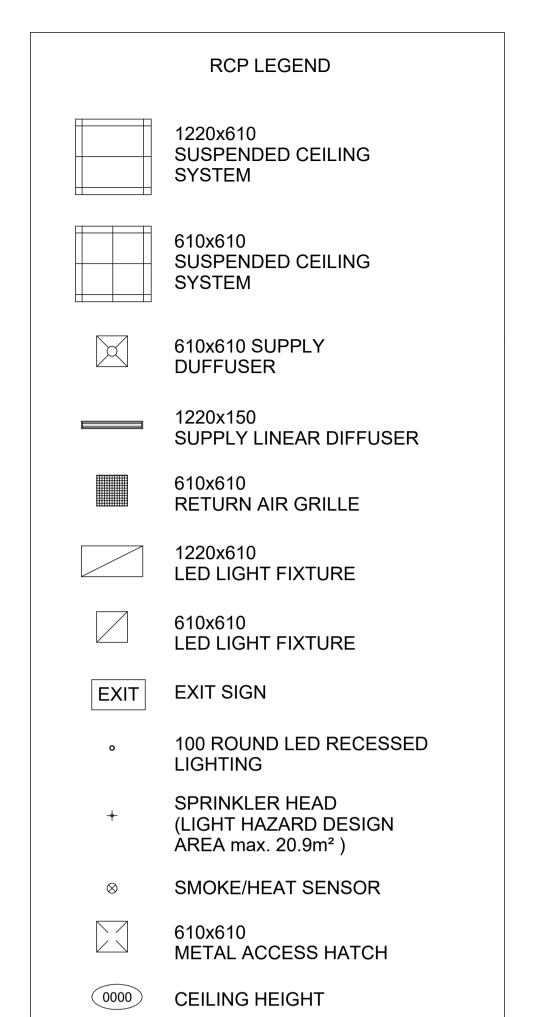
PLAN DETAILS

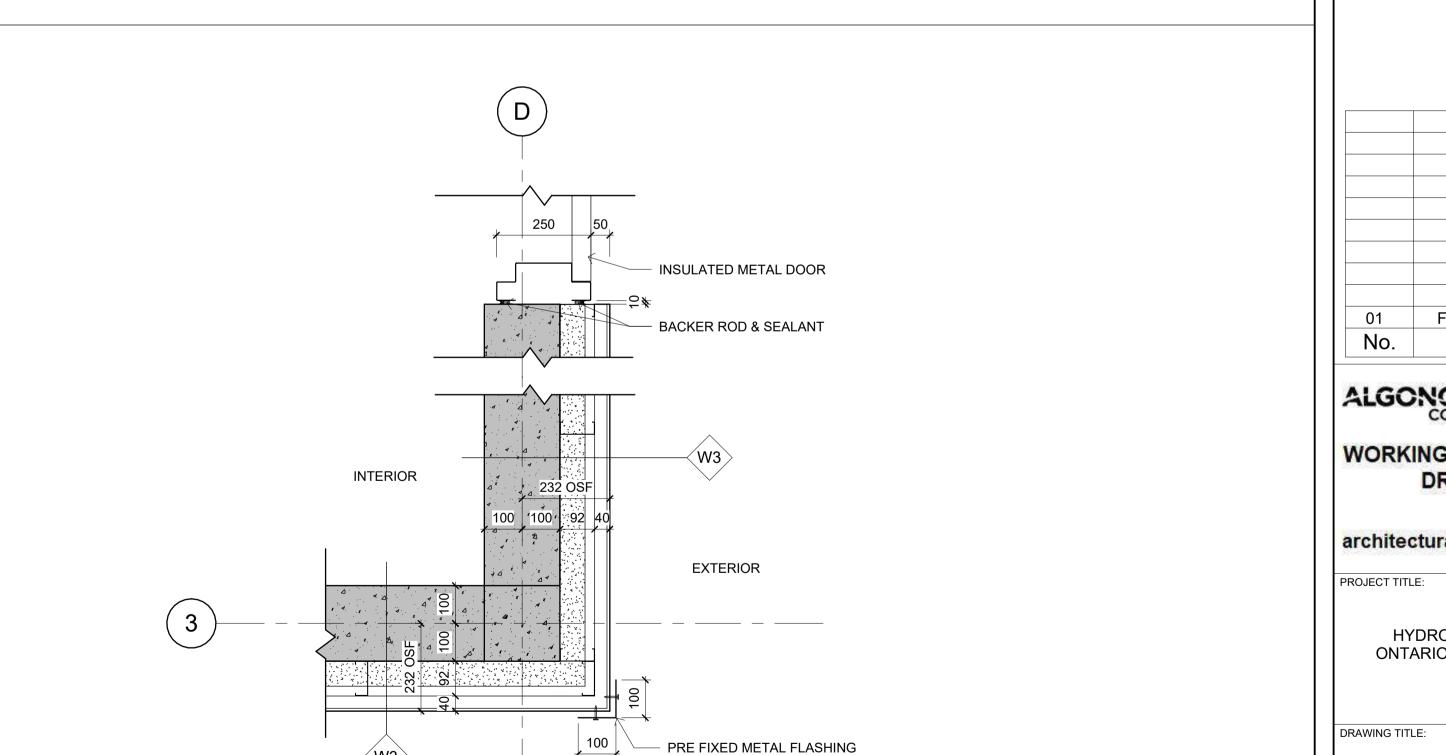
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1 : 10	10/04/2024
ROJECT NUMBER:	DRAWN BY:
WDIV-W24-02	JAMIE CHEUNG

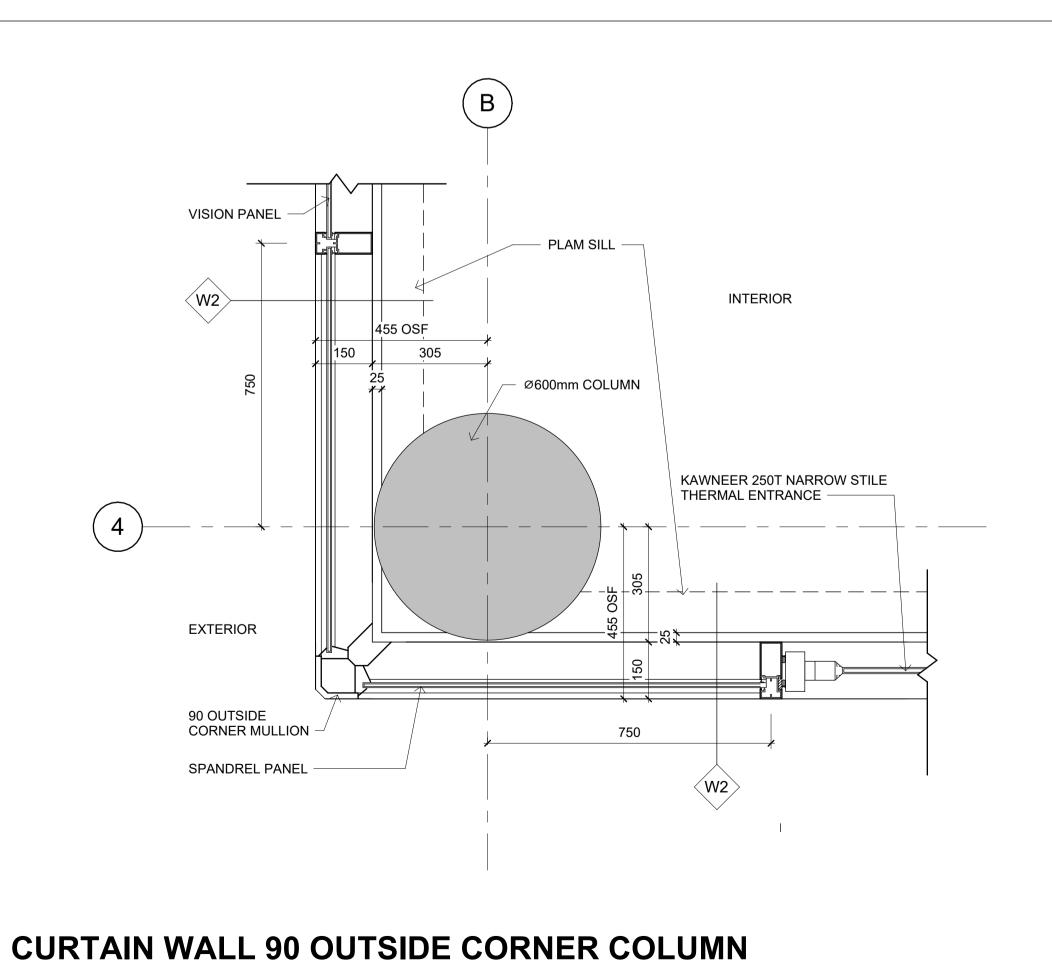
SHEET No.:



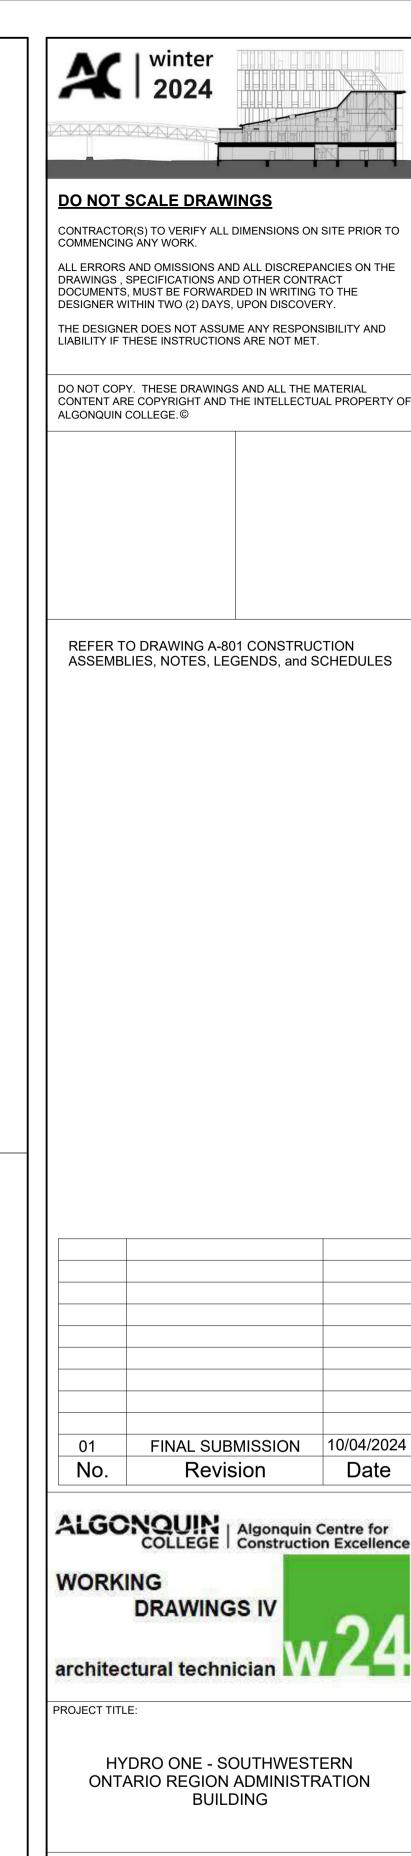

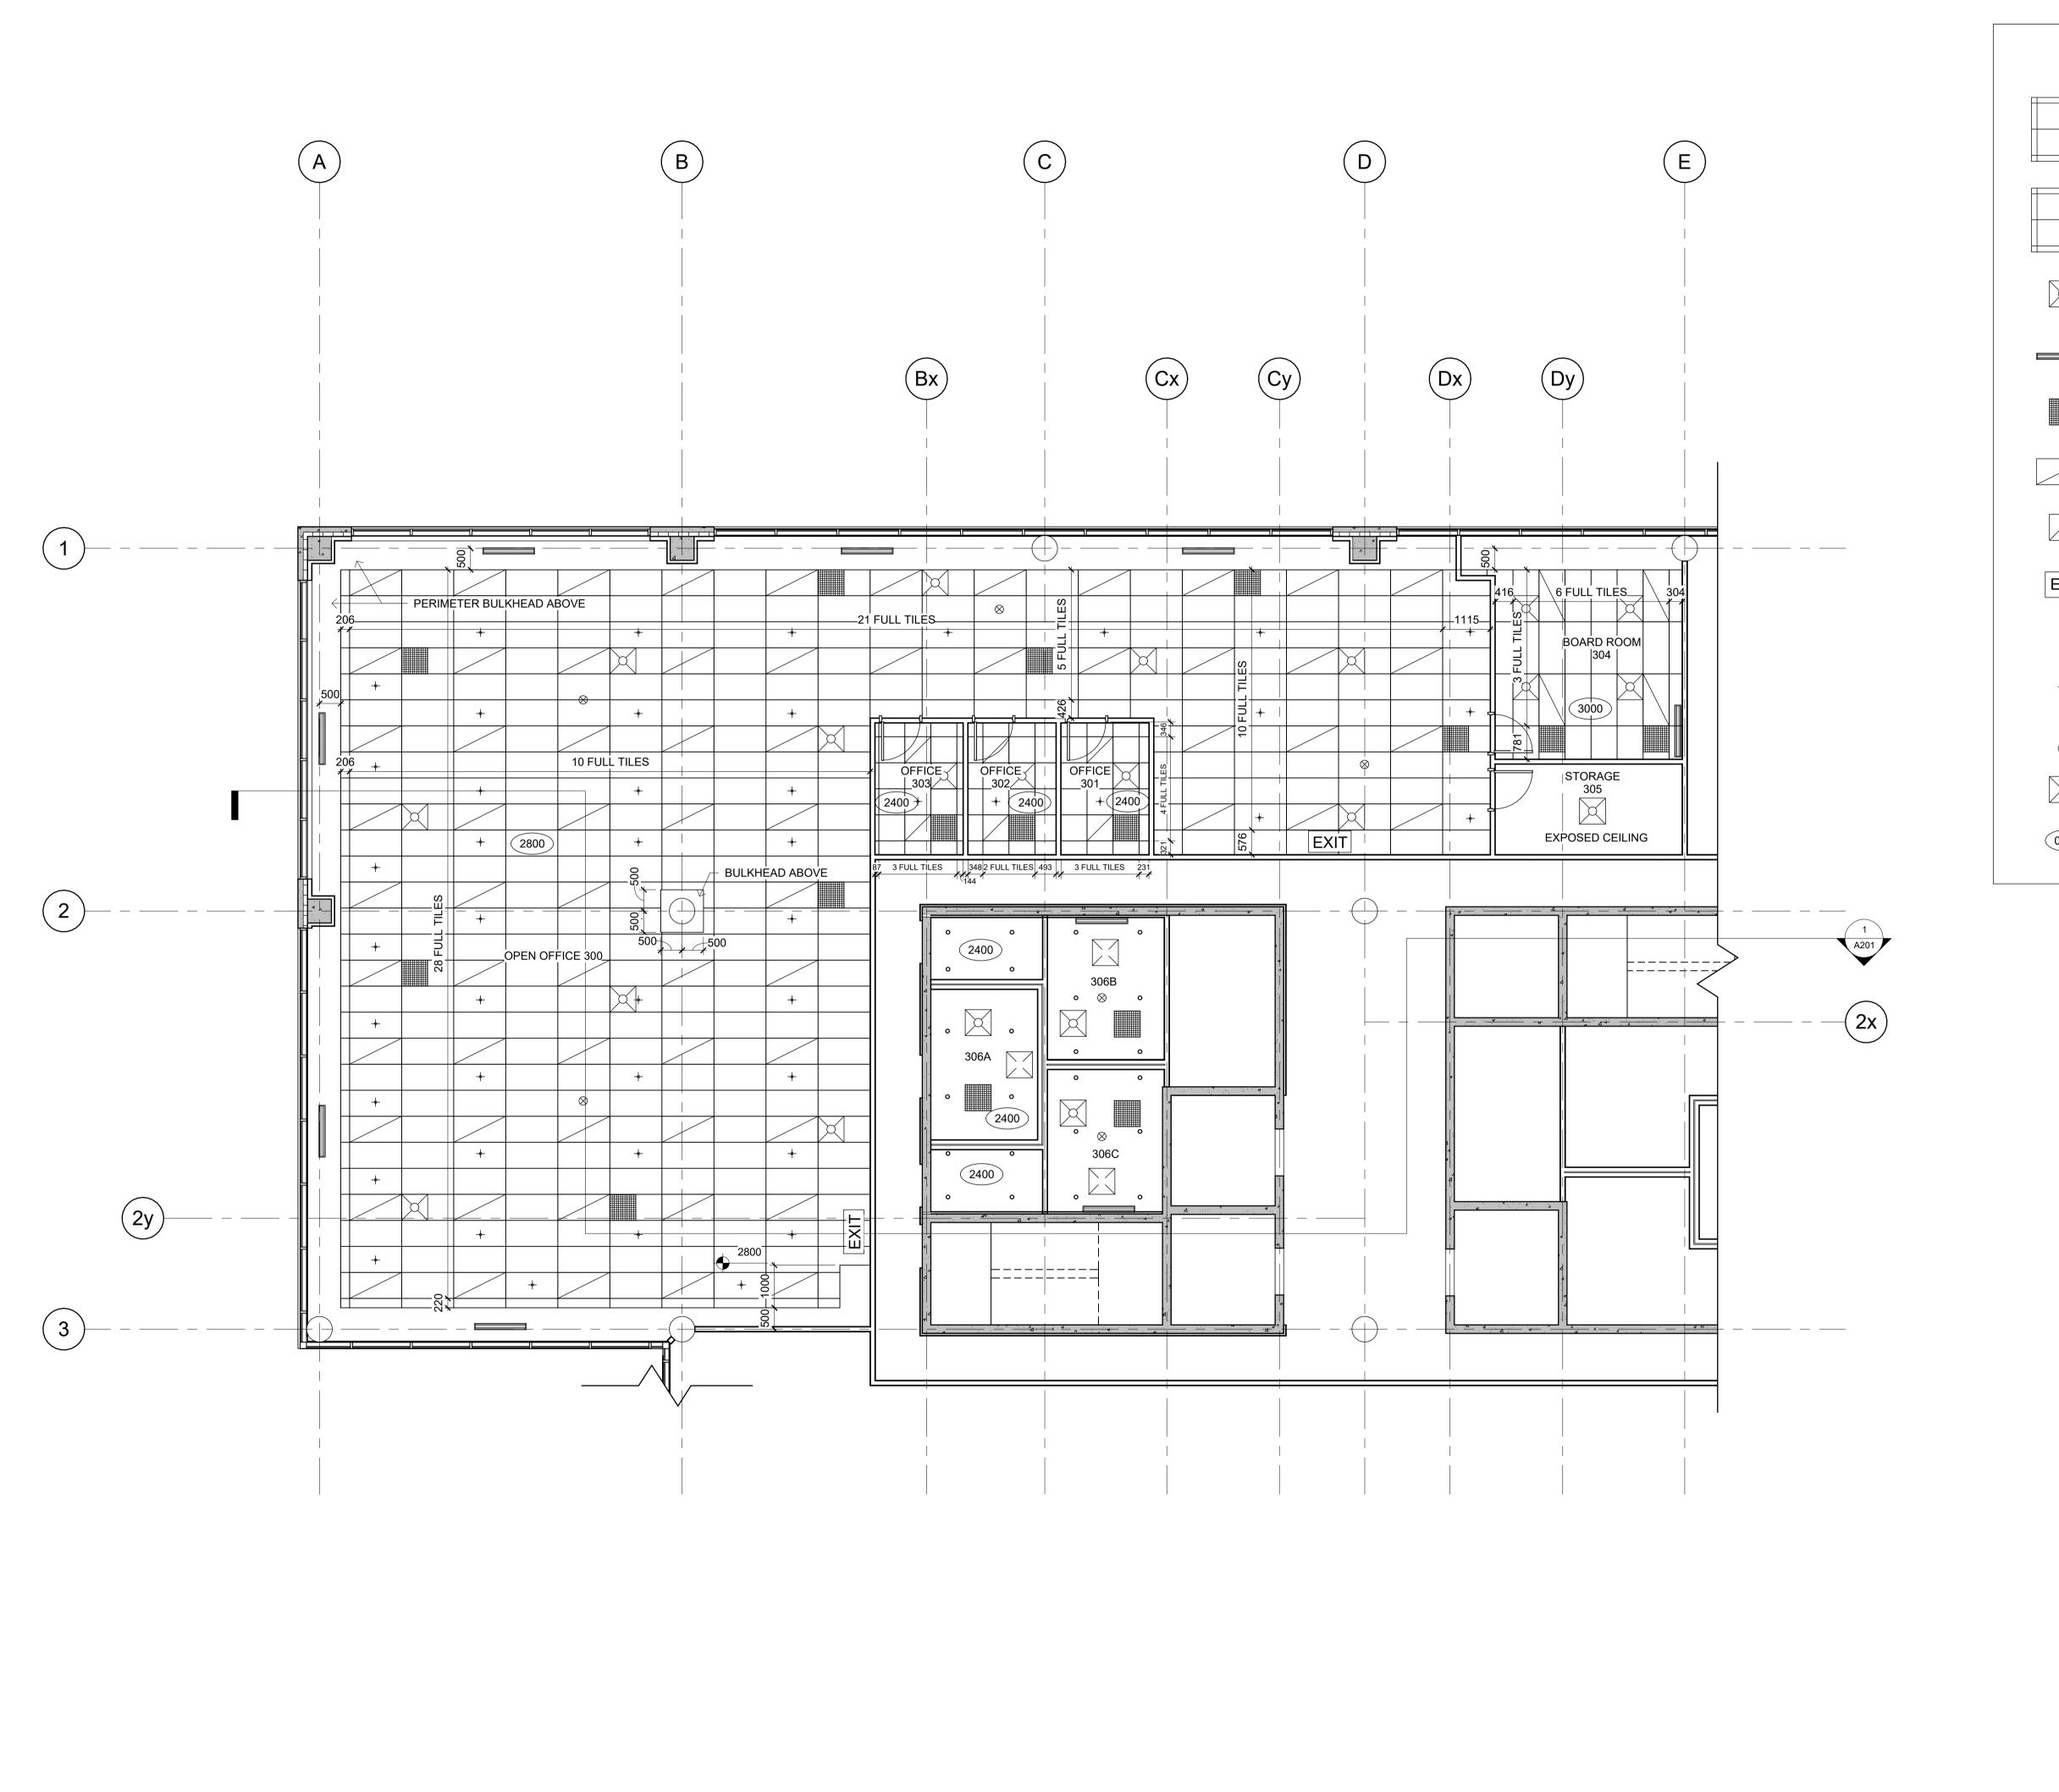

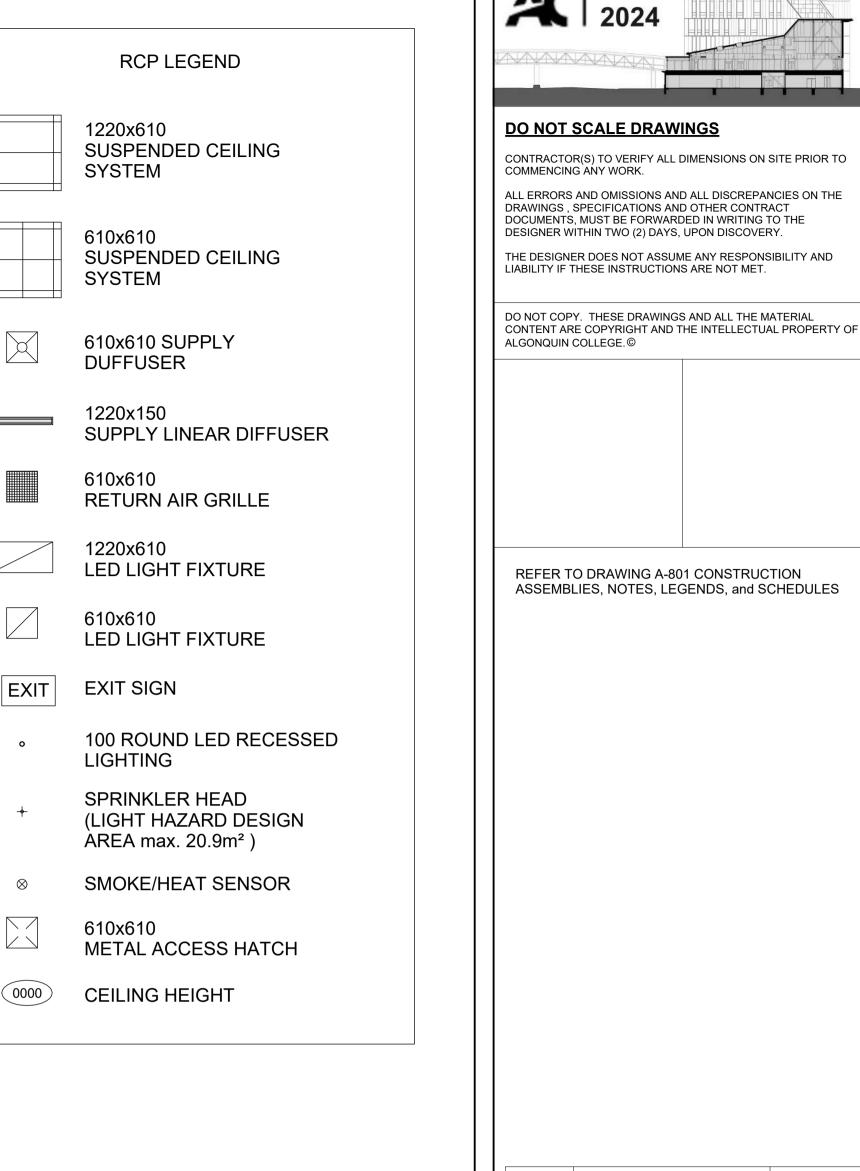

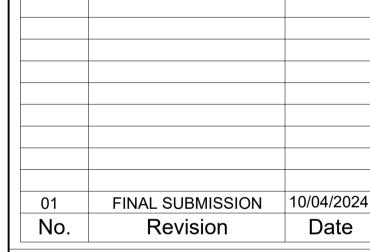

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WORKING **DRAWINGS IV**

architectural technician

PROJECT TITLE:

HYDRO ONE - SOUTHWESTERN ONTARIO REGION ADMINISTRATION BUILDING

DRAWING TITLE:


REFLECTED CEILING PLAN

PROJECT NUMBER:

10/04/2024

JAMIE CHEUNG


WDIV-W24-02 SHEET No.:

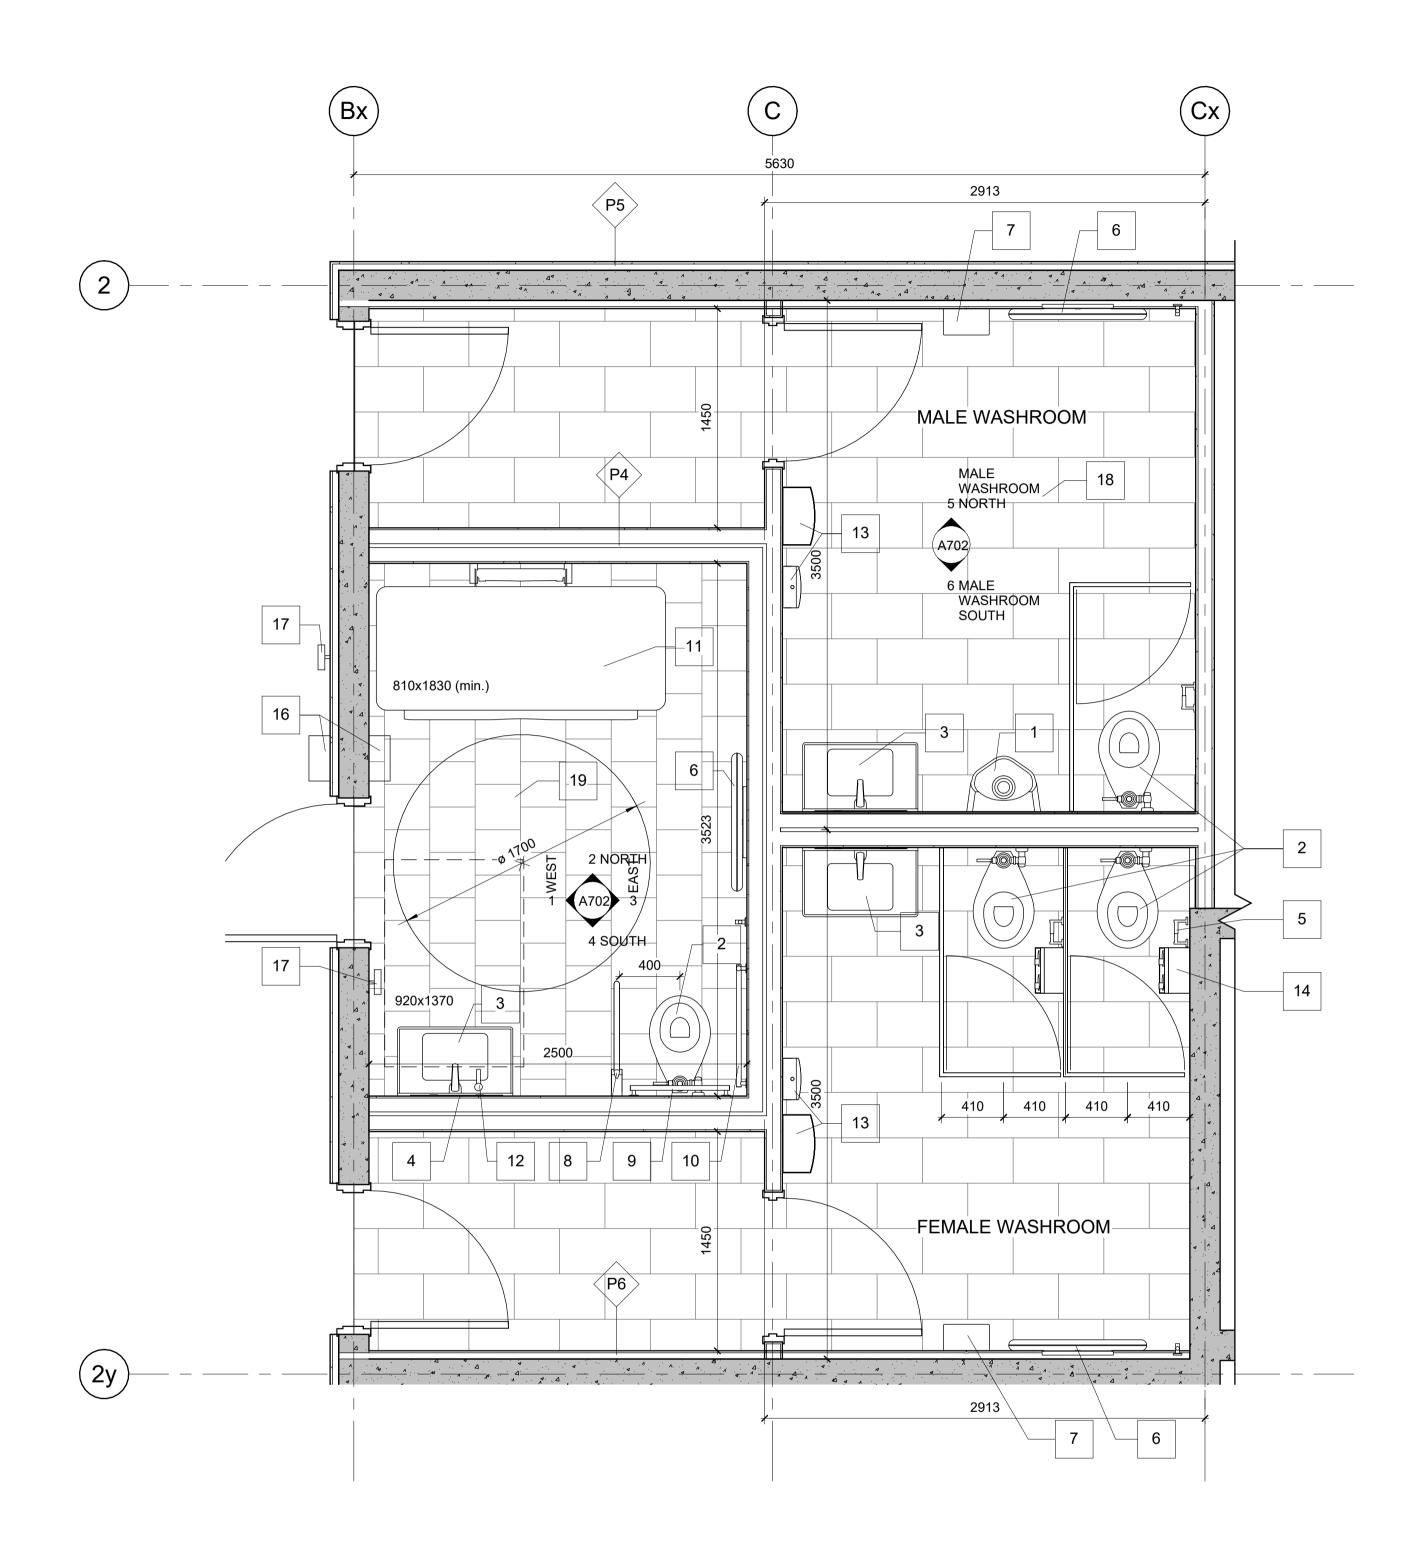

1 **WASHROOM PLAN**A-701 1:25

LEGEND

- 1. HYBRID UNRINAL
- 2. WATER CLOSET
- 3. LAVATORY
- 4. MIRROR
- 5 TOILET PAPER
- 6. BABY CHANGE TABLE
- 7. HAND DRYER
- 8. GRAB RAIL
- 9. 600 GRAB BAR
- 10. 750 x 750 L SHAPED GRAB BAR
- 11 ADULT CHANGE TABLE
- 12. SOAP DISPENSER
- 13. PAPER TOWEL DISPENSER AND GARBAGE
- 14. SANITARY NAPKIN GARBAGE RECEPTACLE
- 15. EMERGENCY CALL SYSTEM
- 16. VISUAL AND AUDIBLE ALARM SIGNAL INSIDE AND
- **OUTSIDE WASHROOM**
- 17. POWER DOOR OPERATER CONTROL
- 18. 600x300 PORCELAIN TILE; PATTERN: RUNNING BOND
- 19. 300x300 PORCELAIN TILE; PATTERN: RUNNING BOND
- 20. BASEBOARD 300x100 PORCELAIN TILE

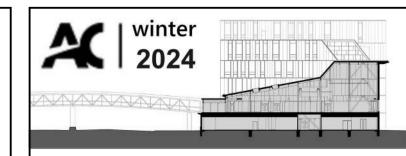

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WORKING DRAWINGS IV

architectural technician

PROJECT TITLE:

HYDRO ONE - SOUTHWESTERN ONTARIO REGION ADMINISTRATION BUILDING

DRAWING TITLE:

WASHROOM PLAN

SCALE:

1:25

PROJECT NUMBER:


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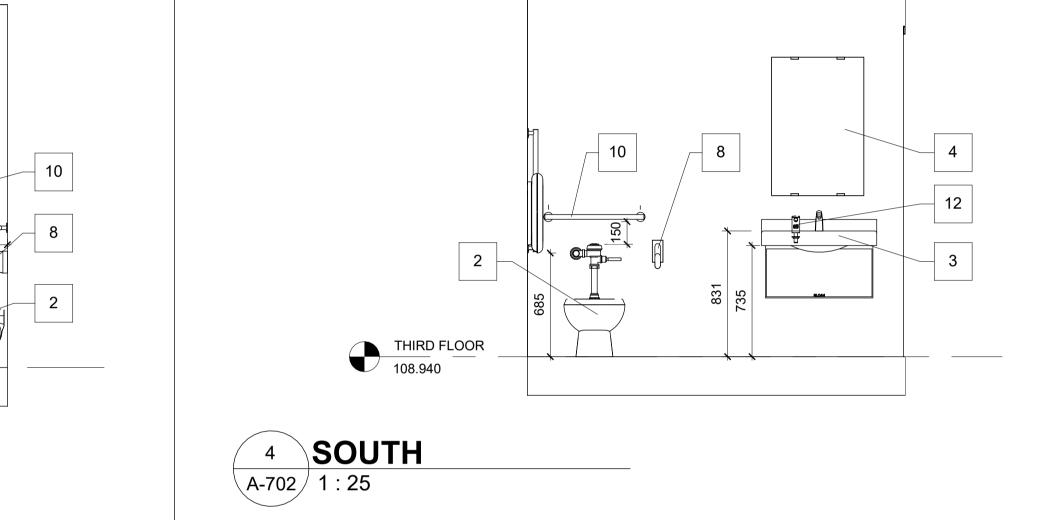
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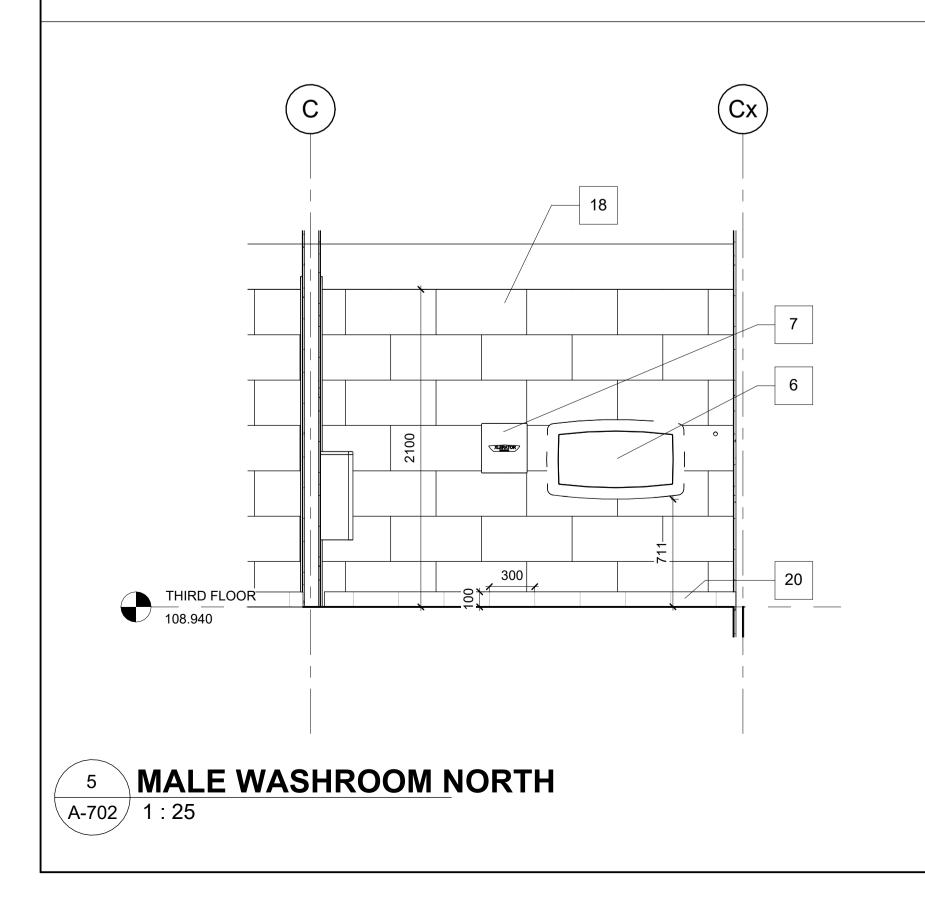
JAMIE CHEUNG

SHEET No.





MALE WASHROOM ELEVATIONS

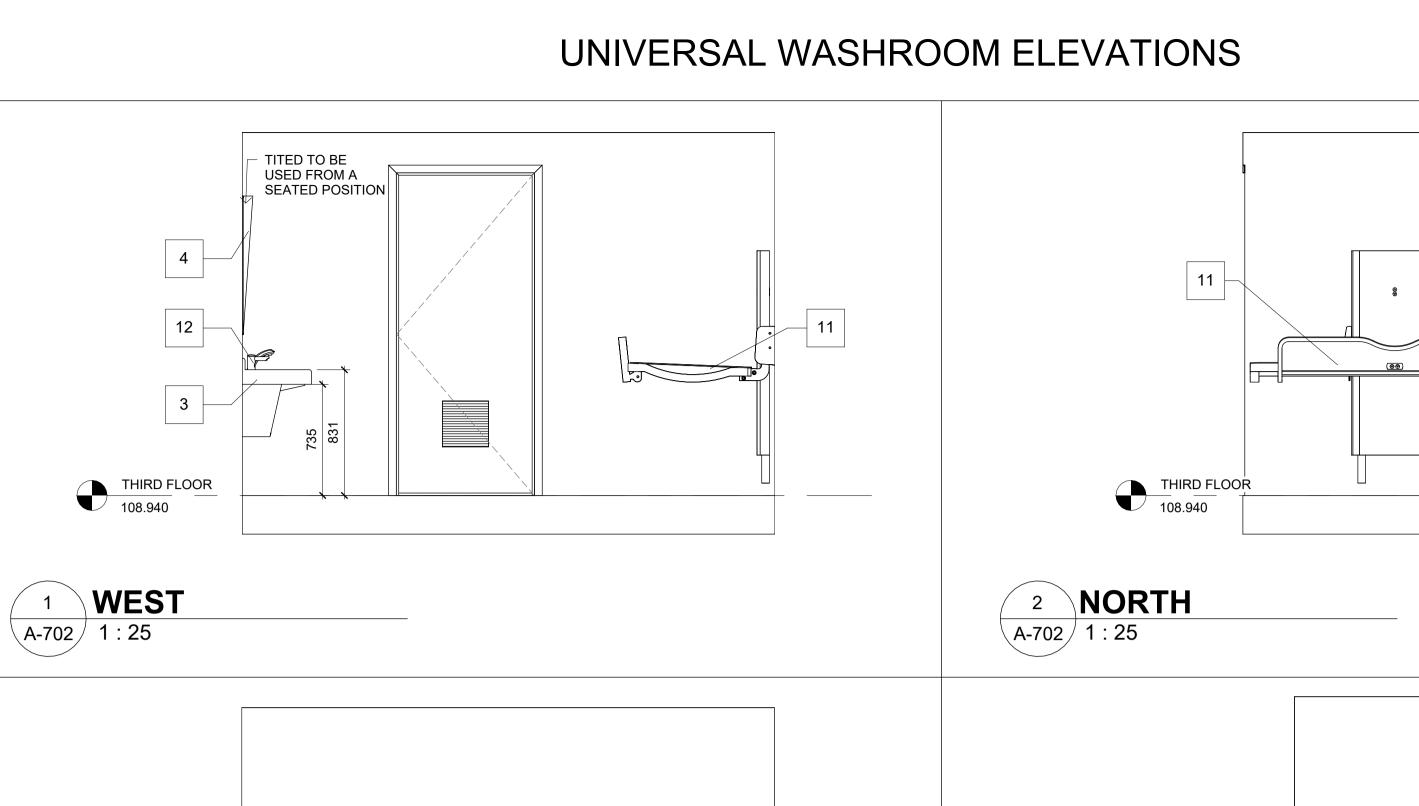


11

THIRD FLOOR
108.940

EAST

A-702 1 : 25

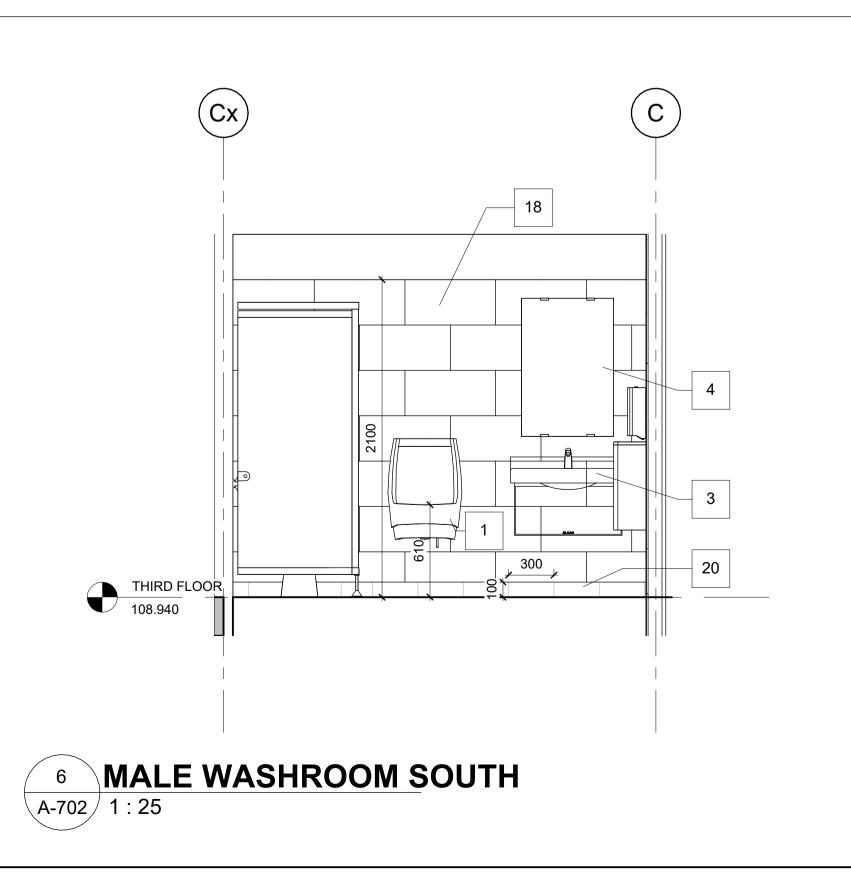


LEGEND

- 1. HYBRID UNRINAL
- 2. WATER CLOSET
- 3. LAVATORY
- 4. MIRROR

6

- 5 TOILET PAPER
- 6. BABY CHANGE TABLE
- 7. HAND DRYER
- 8. GRAB RAIL
- 9. 600 GRAB BAR
- 10. 750 x 750 L SHAPED GRAB BAR
- 11 ADULT CHANGE TABLE
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- 15. EMERGENCY CALL SYSTEM
- 16. VISUAL AND AUDIBLE ALARM SIGNAL INSIDE AND
- **OUTSIDE WASHROOM**
- 17. POWER DOOR OPERATER CONTROL
- 18. 600x300 PORCELAIN TILE; PATTERN: RUNNING BOND 19. 300x300 PORCELAIN TILE; PATTERN: RUNNING BOND
- 20. BASEBOARD 300x100 PORCELAIN TILE

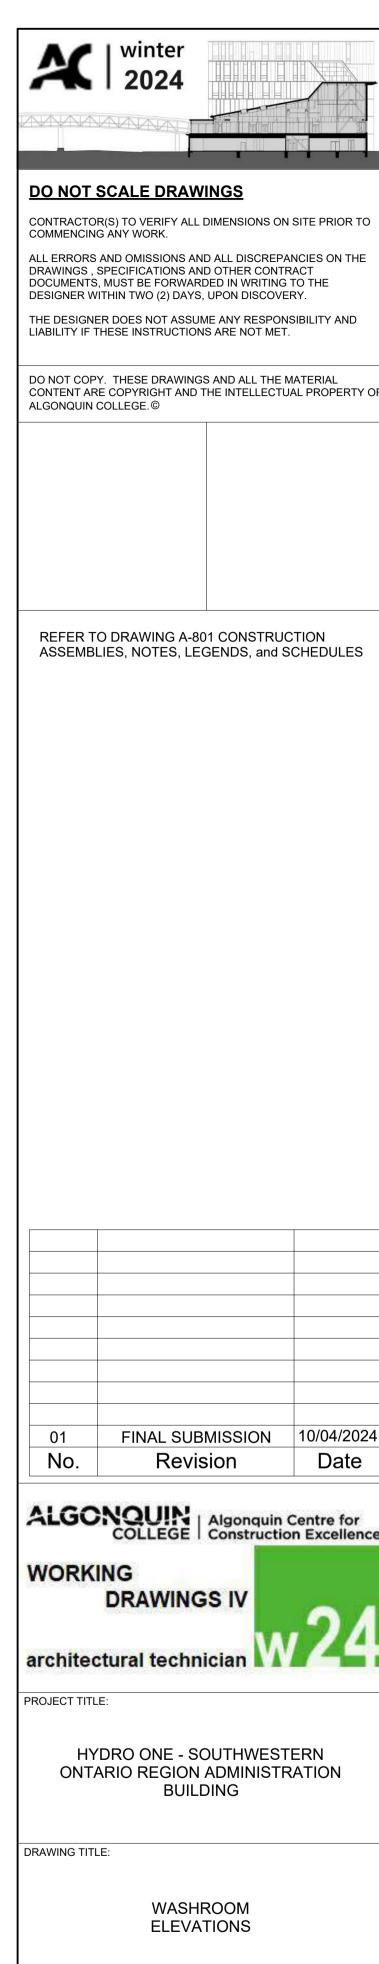


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WDIV-W24-02

JAMIE CHEUNG

10/04/2024

CONSTRUCTION ASSEMBLIES

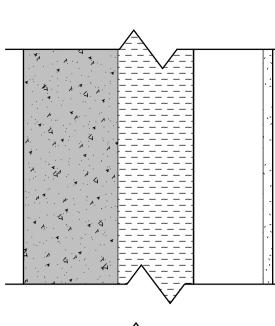

W1 - ARCHITECTURAL PRECAST PANEL WALL SYSTEM

BASIS OF DESIGN

125 ARCHITECTURAL PRECAST PANEL (FACE SEALED SYSTEM), COLOUR = #201 GREY,


FINISH SMOOTH, TEXTURE = SANDBLASTED

SUPPORT 2 WAY ADJUSTABLE DEAD LOAD ANCHOR c/w PVC THERMAL BREAK 100 ROCKWOOL CAVITY® SEMI-RIGID TYPE INSULATION @ 4 R.S.I

AIR/VAPOUR BARRIER

92 0.759mm (21GA.) LIGHTWEIGHT STEEL FRAMING @ 600 o/c

12.7 SHEETROCK® BRAND AR FIRECODE® X PANELS c/w PAINT FINISH

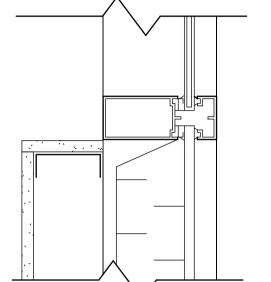


W2 - ALUMINUM AND GLASS CURTAIN WALL SYSTEM

BASIS OF DESIGN

152.4 DEEP FRAME KAWNEER 1600 UT SYSTEM c/w DOUBLE PANEL IGU 24.5 INFILL, CLEAR ANODIZED FRAME FINISH


100 CURTAINROCK® 40 LIGHTWEIGHT SEMI-RIGID STONE WOOL INSULATION BOARDTYPE INSULATION @ ALL NON-VISION SPANDREL PANELS @ 3 R.S.I

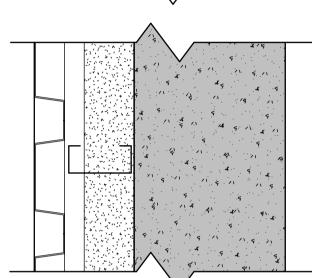

W3 - METAL SHEET CLADDING STEEL WALL SYSTEM


BASIS OF DESIGN

40 VICWEST CL7040, TYPE = EXPOSED FASTENER CLADDING, COLOUR = STONE GREY, 56071 G90, THICKNESS = 0.853mm (22ga.), DIRECTION = HORIZONTAL 92 0.759mm (21GA.) LIGHTWEIGHT STEEL FRAMING @ 600 o/c POLARFOAM® CLÓSED CELL SPRAY FOAM TYPE INSULATION @ 4 R.S.I 200 CONCRETE SHEAR WALL c/w PAINT FINISH

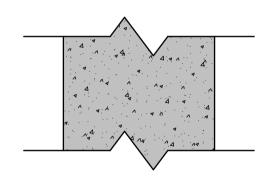


W4: INTERIOR WALL

200mm CONCRETE SHEAR WALL

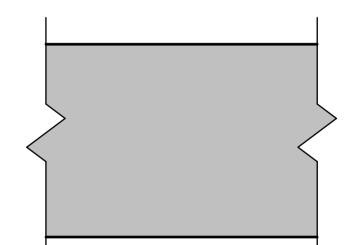

F1: FLOOR

255mm CONCRETE SLAB

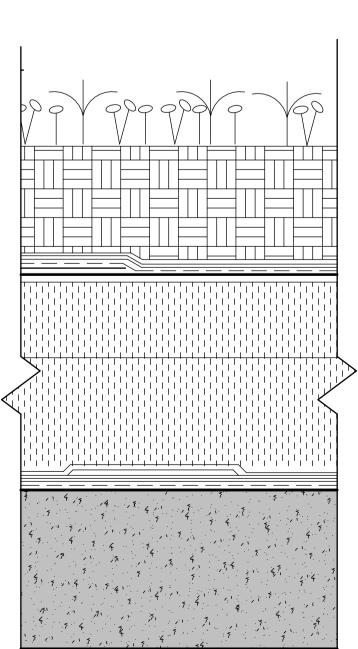


R1- PROTECTED MEMBRANE ROOFING SYSTEM

BASIS OF DESIGN

SOPRANATURE® VEGETATIVE (GREEN) EXTENSIVE TYPE ROOF SYSTEM 100 POLYISO RIGID TYPE INSULATION (TAPERED - 2% SLOPE TO SUCPPER) 175 EXTRUDED POLYSTYRENE (XPS) RIGID TYPE INSULATION @ 7 R.S.I SOPREMA 2-PLY MODIFIED BITUMININOUS MEMBRANE SYSTEM AIR/VAPOUR BARRIER

210 35MPa CONCRETE SLAB

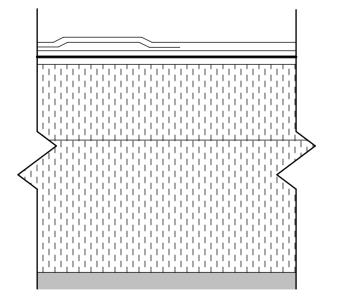

16 GYPSUM WALL BOARD C/W PAINT FINISH

P1: INTERIOR WALL

P2: INTERIOR WALL

c/w MINERAL WOOL BATT INS.


13 GYPSUM WALL BOARD C/W PAINT FINISH

16 GYPSUM WALL BOARD C/W PAINT FINISH

64mm 0.759mm (21GA.) LIGHTWEIGHT STEEL FRAMING

P3: INTERIOR WALL 13 GYPSUM WALL BOARD C/W PAINT FINISH 92mm LIGHTWEIGHT STEEL FRAMING, BACKUP @ 600 O.C c/w MINERAL WOOL BATT INS. 13 GYPSUM WALL BOARD C/W PAINT FINISH


92mm LIGHTWEIGHT STEEL FRAMING, BACKUP @ 600 O.C

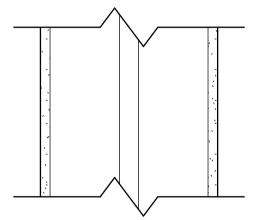

P4: PLUMBING WALL


13 GYPSUM WALL BOARD C/W PAINT FINISH 92mm LIGHTWEIGHT STEEL FRAMING, BACKUP @ 600 O.C c/w MINERAL WOOL BATT INS. 25 AIR SPACE

92mm LIGHTWEIGHT STEEL FRAMING, BACKUP @ 600 O.C c/w MINERAL WOOL BATT INS. 13 GYPSUM WALL BOARD C/W PAINT FINISH

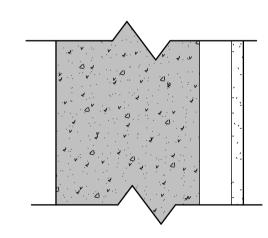

P5: INTERIOR WALL

16 GYPSUM WALL BOARD C/W PAINT FINISH 42mm STEEL FRAMING, @ 600 O.C 200 CONCRETE SHEAR WALL

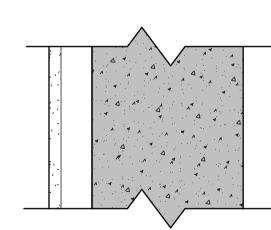

BASIS OF DESIGN

AIR/VAPOUR BARRIER

METAL FASCIA EDGE TERMINATION

P6: INTERIOR WALL

16 GYPSUM WALL BOARD C/W PAINT FINISH 42mm STEEL FRAMING, @ 600 O.C 200 CONCRETE SHEAR WALL


R2- CONVENTIONAL ROOFING SYSTEM (@CORE EXTENSION)

SOPREMA 2-PLY MODIFIED BITUMININOUS MEMBRANE SYSTEM

SOPRANATURE® VEGETATIVE (GREEN) EXTENSIVE TYPE ROOF SYSTEM

175 EXTRUDED POLYSTYRENE (XPS) RIGID TYPE INSULATION @ 7 R.S.I

100 POLYISO RIGID TYPE INSULATION (TAPERED - 2% SLOPE TO SUCPPER)

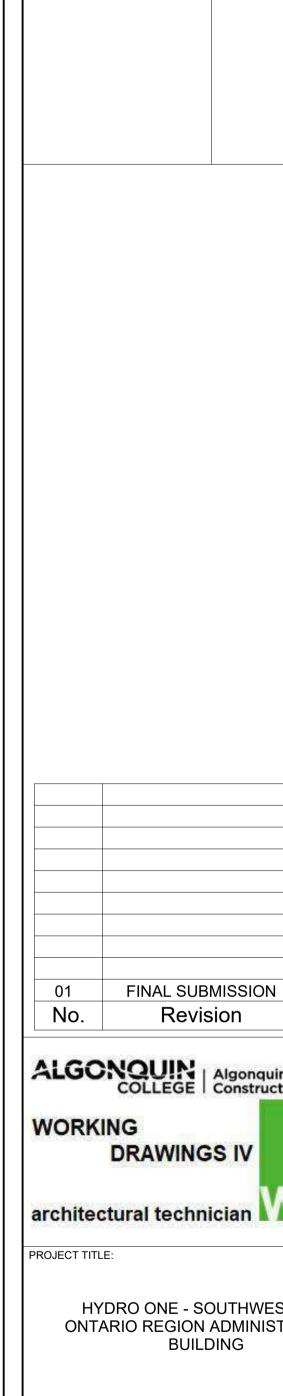

DO NOT SCALE DRAWINGS

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HYDRO ONE - SOUTHWESTERN ONTARIO REGION ADMINISTRATION

10/04/2024

DRAWING TITLE:

CONSTRUCTION **ASSEMBLIES**

WDIV-W24-02

A801

10/04/2024 **JAMIE CHEUNG**